

#### Transmittal Page 1 of 2

To: Planning Department

CC: Manbir Deol

City of Kelowna avasa.md@gmail.com

December 18, 2023

Re: Design Rationale for the Proposed Development of 1016 Martin Ave, Kelowna, BC (The Site)

Dear City of Kelowna Planning Department,

Further to submitted information as it pertains to the Development Permit application associated with the proposed Development of 1016 Martin Avenue in Kelowna, we offer the following Rationale for the project:

Located on the corner of Graham Street and Martin Avenue, Martin Avenue is located between the Downtown and Bankhead area of Kelowna. The development is within the core area, and is close to shopping, personal services, and restaurants allowing most errands from the location to be accomplished by foot. This property boasts a Bike Score of 97 and a Walk Score of 84, making the downtown core and surrounding community easily accessible. Kelowna's Downtown area is ideally located for multi-unit residential use as the area is experiencing tremendous population growth with low market availability. Because of its associated high walk score and bike score, the reliance on automobile use is greatly reduced allowing the area to diversify while creating healthy community practices and reducing the residents carbon footprint.

The building design includes 4 easily accessible units with all entries on ground level and a shared detached garage for the residences. The reduction in automobile reliance in conjunction with the higher density infill development of the property contribute to a more sustainable approach to the building design that aligns with the City of Kelowna's Healthy City Strategy and planning initiatives. The design concept for the building includes providing the required private outdoor space in the form of rooftop decks for each of the 4 residences.

The priority to densify precious, developable land within an existing core area while ensuring the neighbouring properties were respected resulted in a building that is under the 8m height requirement set out by the proposed MF1 zoning. Achieving 4 residences on the property while being sensitive to the neighbourhood was felt to be important from a location and sustainability standpoint. The result is an attractive infill project that provides needed residential units, addresses the human scale while being sensitively designed to reduce impact on neighbouring properties.

In summary, the rationale for this project is as follows:

- i. Provide a thoughtful, sustainable infill housing solution to a property located within the core area of Kelowna.
- ii. Provide 4 residences that provide generous private outdoor amenity spaces for each unit.



#### **Transmittal** Page 2 of 2

- iii. The proposed development meets the City of Kelowna Parking Bylaw requirements. Specifically, and in conjunction with zoning requirements, the project provides the required vehicle parking space for all 4 residences (4 stalls).
- iv. The proposed development results in a building design that is attractive in its design, is inviting and addresses the human scale at ground level as well is sensitive to the neighbourhood at large by the way it has been designed and massed on the site.
- v. The proposed development provides the required 4 short-term bicycle storge spaces and as well accommodated for 4 long-term bicycle stalls located inside the detached garage.

This proposed development recognizes the City of Kelowna's strategic approach to overall growth including better use of precious developable land in accordance with the City's OCP/Future Land Use, Healthy City Strategy, and planning initiatives.

We look forward to your supportive comments in response to this Rezoning/Development Variance Permit application.

Please do not hesitate to contact our office if you have any questions or require additional information in these matters.

Sincerely:

Matt Johnston //

Architect AIBC, LEED AP

LIME Architecture Inc.

# 1016 MARTIN AVE, KELOWNA BC





SITE KEY PLAN

### ARCHITECTURAL SHEET LIST

A-000 COVER SHEET
A-001 PROJECT INFORMATION
A-002 GENERAL NOTES
A-003 ASSEMBLIES
A-101 LEVEL 1 PLAN
A-102 LEVEL 2 PLAN
A-103 ROOFTOP DECK PLAN
A-200 ELEVATIONS
A-201 ELEVATIONS
A-202 ELEVATIONS
A-203 SECTIONS
A-300 SECTIONS
A-500 DETAILS

DETAILS

A-501

# Architecture Inc. All Contracting Trades shall check and verify all levels, dimensions, data and conditions on the site prior to commencement of any work. Any discrepancies are to be reported immediately to LIME Architecture Inc. Do not Scale any dimensions from this drawing. All trades are to execute the work in accordance with the current municipality.

COPYRIGHT.
ALL RIGHTS RESERVED

All ideas, designs, drawings and specifications are the exclusive property of

LIME Architecture Inc. As instruments of service, they may not be used or reproduced in any manner without the expressed written consent of LIME

PHONE:250-448-7801

205-1626 Richter Street, Kelowna, BC V1Y 2M3

All trades are to execute the work in accordance with the current municipality building by-laws and requirements of other local authorities having jurisdiction as well as the british columbia building code - (most recent edition) including all published revisions and addenda. All trades shall assume full responsiblity for the locations and protection of all under and above ground utilities, wires and conduit connections, including (but not limited to) water, sewer, gas, hydro and telephone.

Revision No., Date and Description

10.03.23 FOR DP

## PROPERTY DESCRITION

CIVIC: 1016 MARTIN AVENUE, KELOWNA BC

LEGAL: LOT A, PLAN KAP21903

### CONSULTANT TEAM

OWNER/ OPERATOR ARCHITECTURAL

LIME Architecture 205-1626 Richter Street Kelowna, BC V1Y 2M3 250-448-7801

Contact(s): Contact(s): Rae-Lynn Labelle

**Plot Date** 10.03.23


10.03.23
PROJECT

1016 MARTIN AVE

DRAWING TITLE

COVER SHEET

Drawing No.

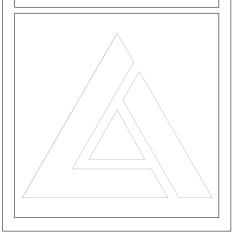

# 1016 MARTIN AVE, KELOWNA BC

### PROPERTY DESCRIPTION:

CIVIC: 1016 MARTIN AVENUE, KELOWNA BC

LEGAL: LOT A, PLAN KAP21903

### **ZONING CALCULATIONS:**

CURRENT: CITY OF KELOWNA MF1 ZONING

CORE AREA
PROPOSED: MF1 ZONING

### **SITE INFORMATION:**

GROSS SITE AREA =

 ALLOWED/REQUIRED
 PROPOSED

 SITE COVERAGE =
 55% (3,669.05 SF)
 41% (2,768 SF)

 SITE COVERAGE + HARDSCAPING =
 75% (5,003.42 SF)
 55% (3,666 SF)

 FAR =
 0.8 (5,336.98 SF)
 0.79 (5,240 SF)

6,671.22 SF (619.78 m<sup>2</sup>)

 $HEIGHT = 8.0 \text{ m ( 2 STOREYS)} \qquad 7.71 \text{ m ( 2 STOREYS)}$ 

YARD SETBACKS:

FRONT YARD =4.0 m 4.95 m FRONT YARD BUILDING STEPACK = N/A N/A SIDE YARD =1.2 m 2.0 m SIDE YARD (GARAGE) =1.2 m 1.68 m REAR YARD (FROM LANE) =0.9 m 1.3 m 4.56 m SEPERATION BETWEEN BUILDINGS = 2.0 m

PARKING CALCULATIONS:

3 BEDROOM UNITS =


(LESS THAN 5 DWELLING UNITS) 4 UNITS x 1 = 4VISITOR = 0

LONG-TERM BICYCLE STORAGE:

TOWNHOMES WITH PRIVATE GARAGE = 0

SHORT-TERM BICYCLE STORAGE:

1 PER RESIDENCE =

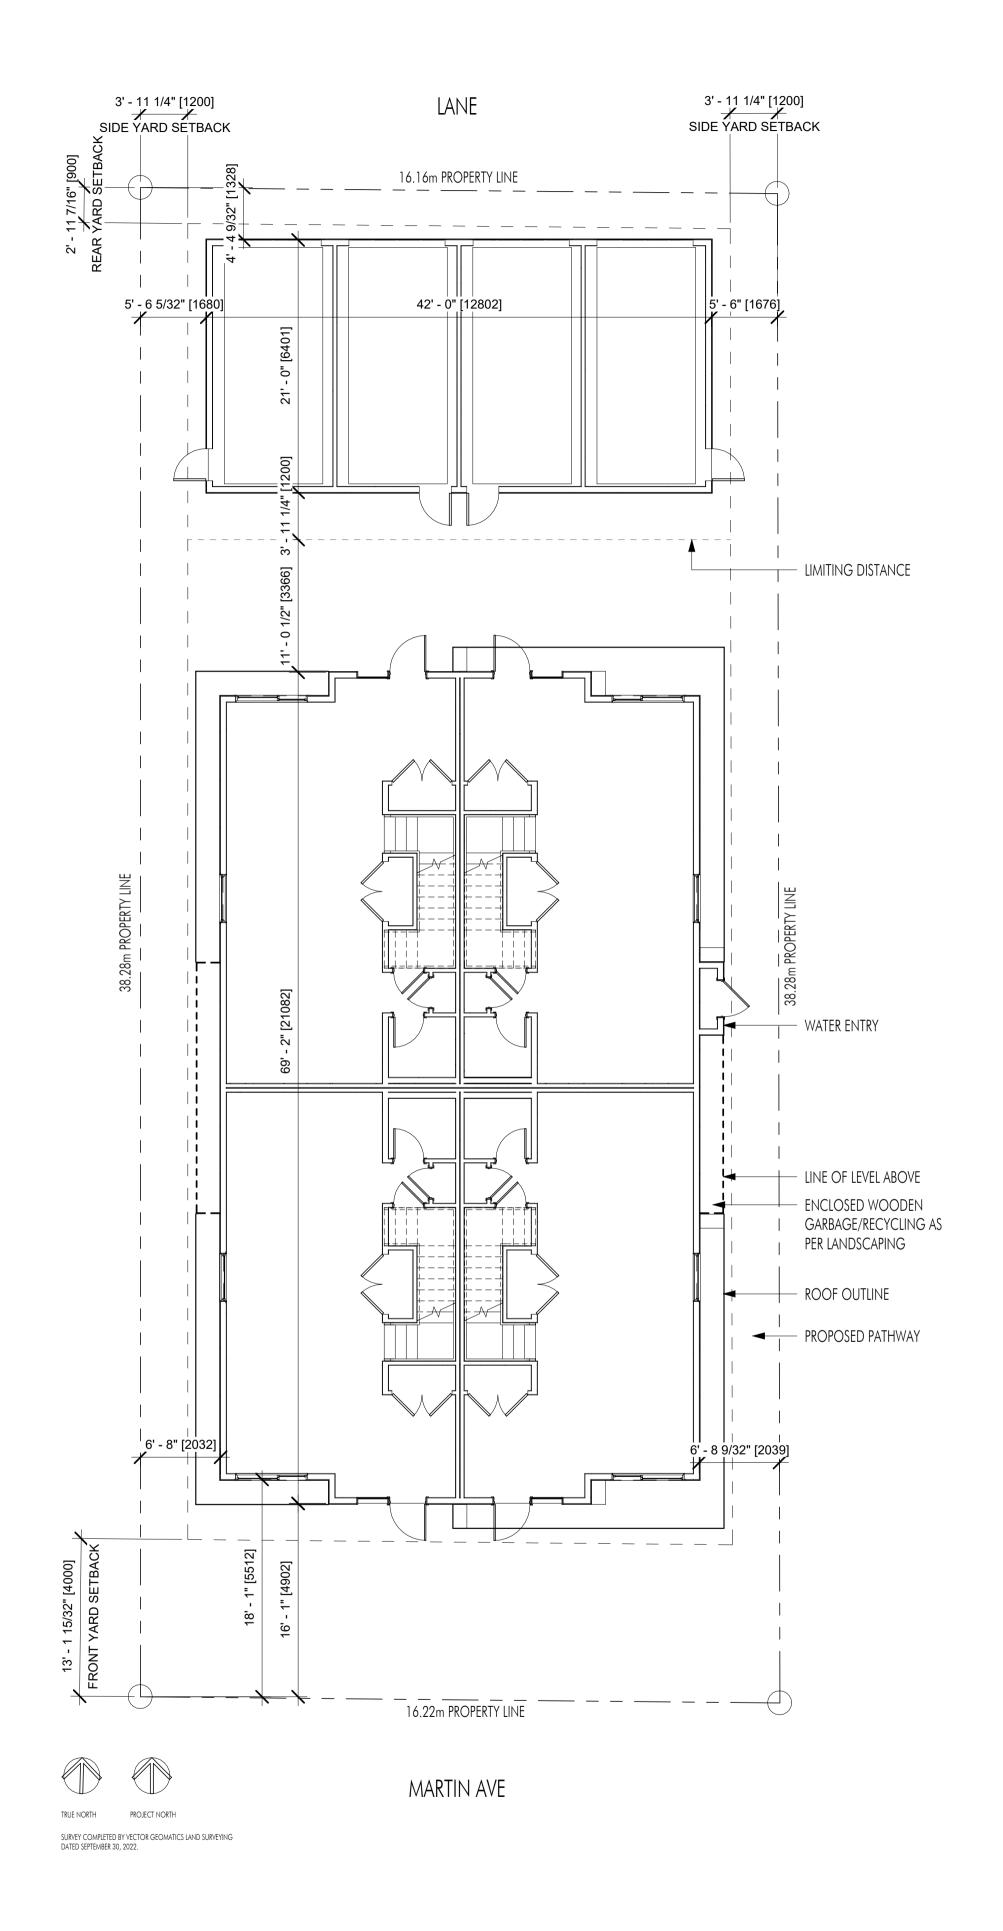



PHONE:250-448-7801

205-1626 Richter Street, Kelowna, BC V1Y 2M3 ww.limearchitecture.com

COPYRIGHT.
ALL RIGHTS RESERVED

All ideas, designs, drawings and specifications are the exclusive property of LIME Architecture Inc. As instruments of service, they may not be used or reproduced in any manner without the expressed written consent of LIME Architecture Inc. All Contracting Trades shall check and verify all levels, dimensions, data and conditions on the site prior to commencement of any work. Any discrepancies are to be reported immediately to LIME Architecture Inc. Do not Scale any dimensions from this drawing.

All trades are to execute the work in accordance with the current municipality building by-laws and requirements of other local authorities having jurisdiction as well as the british columbia building code - (most recent edition) including all published revisions and addenda. All trades shall assume full responsibility for the locations and protection of all under and above ground utilities, wires and conduit connections, including (but not limited to) water, sewer, gas, hydro and telephone.

Revision No., Date and Description


07.27.23 FOR COORDINATION 10.03.23 FOR DP


Plot Date 10.03.23 PROJECT

PROJECT 1016 MARTIN AVE

PROJECT INFORMATION Drawing No.

DRAWING TITLE

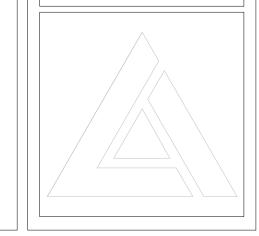

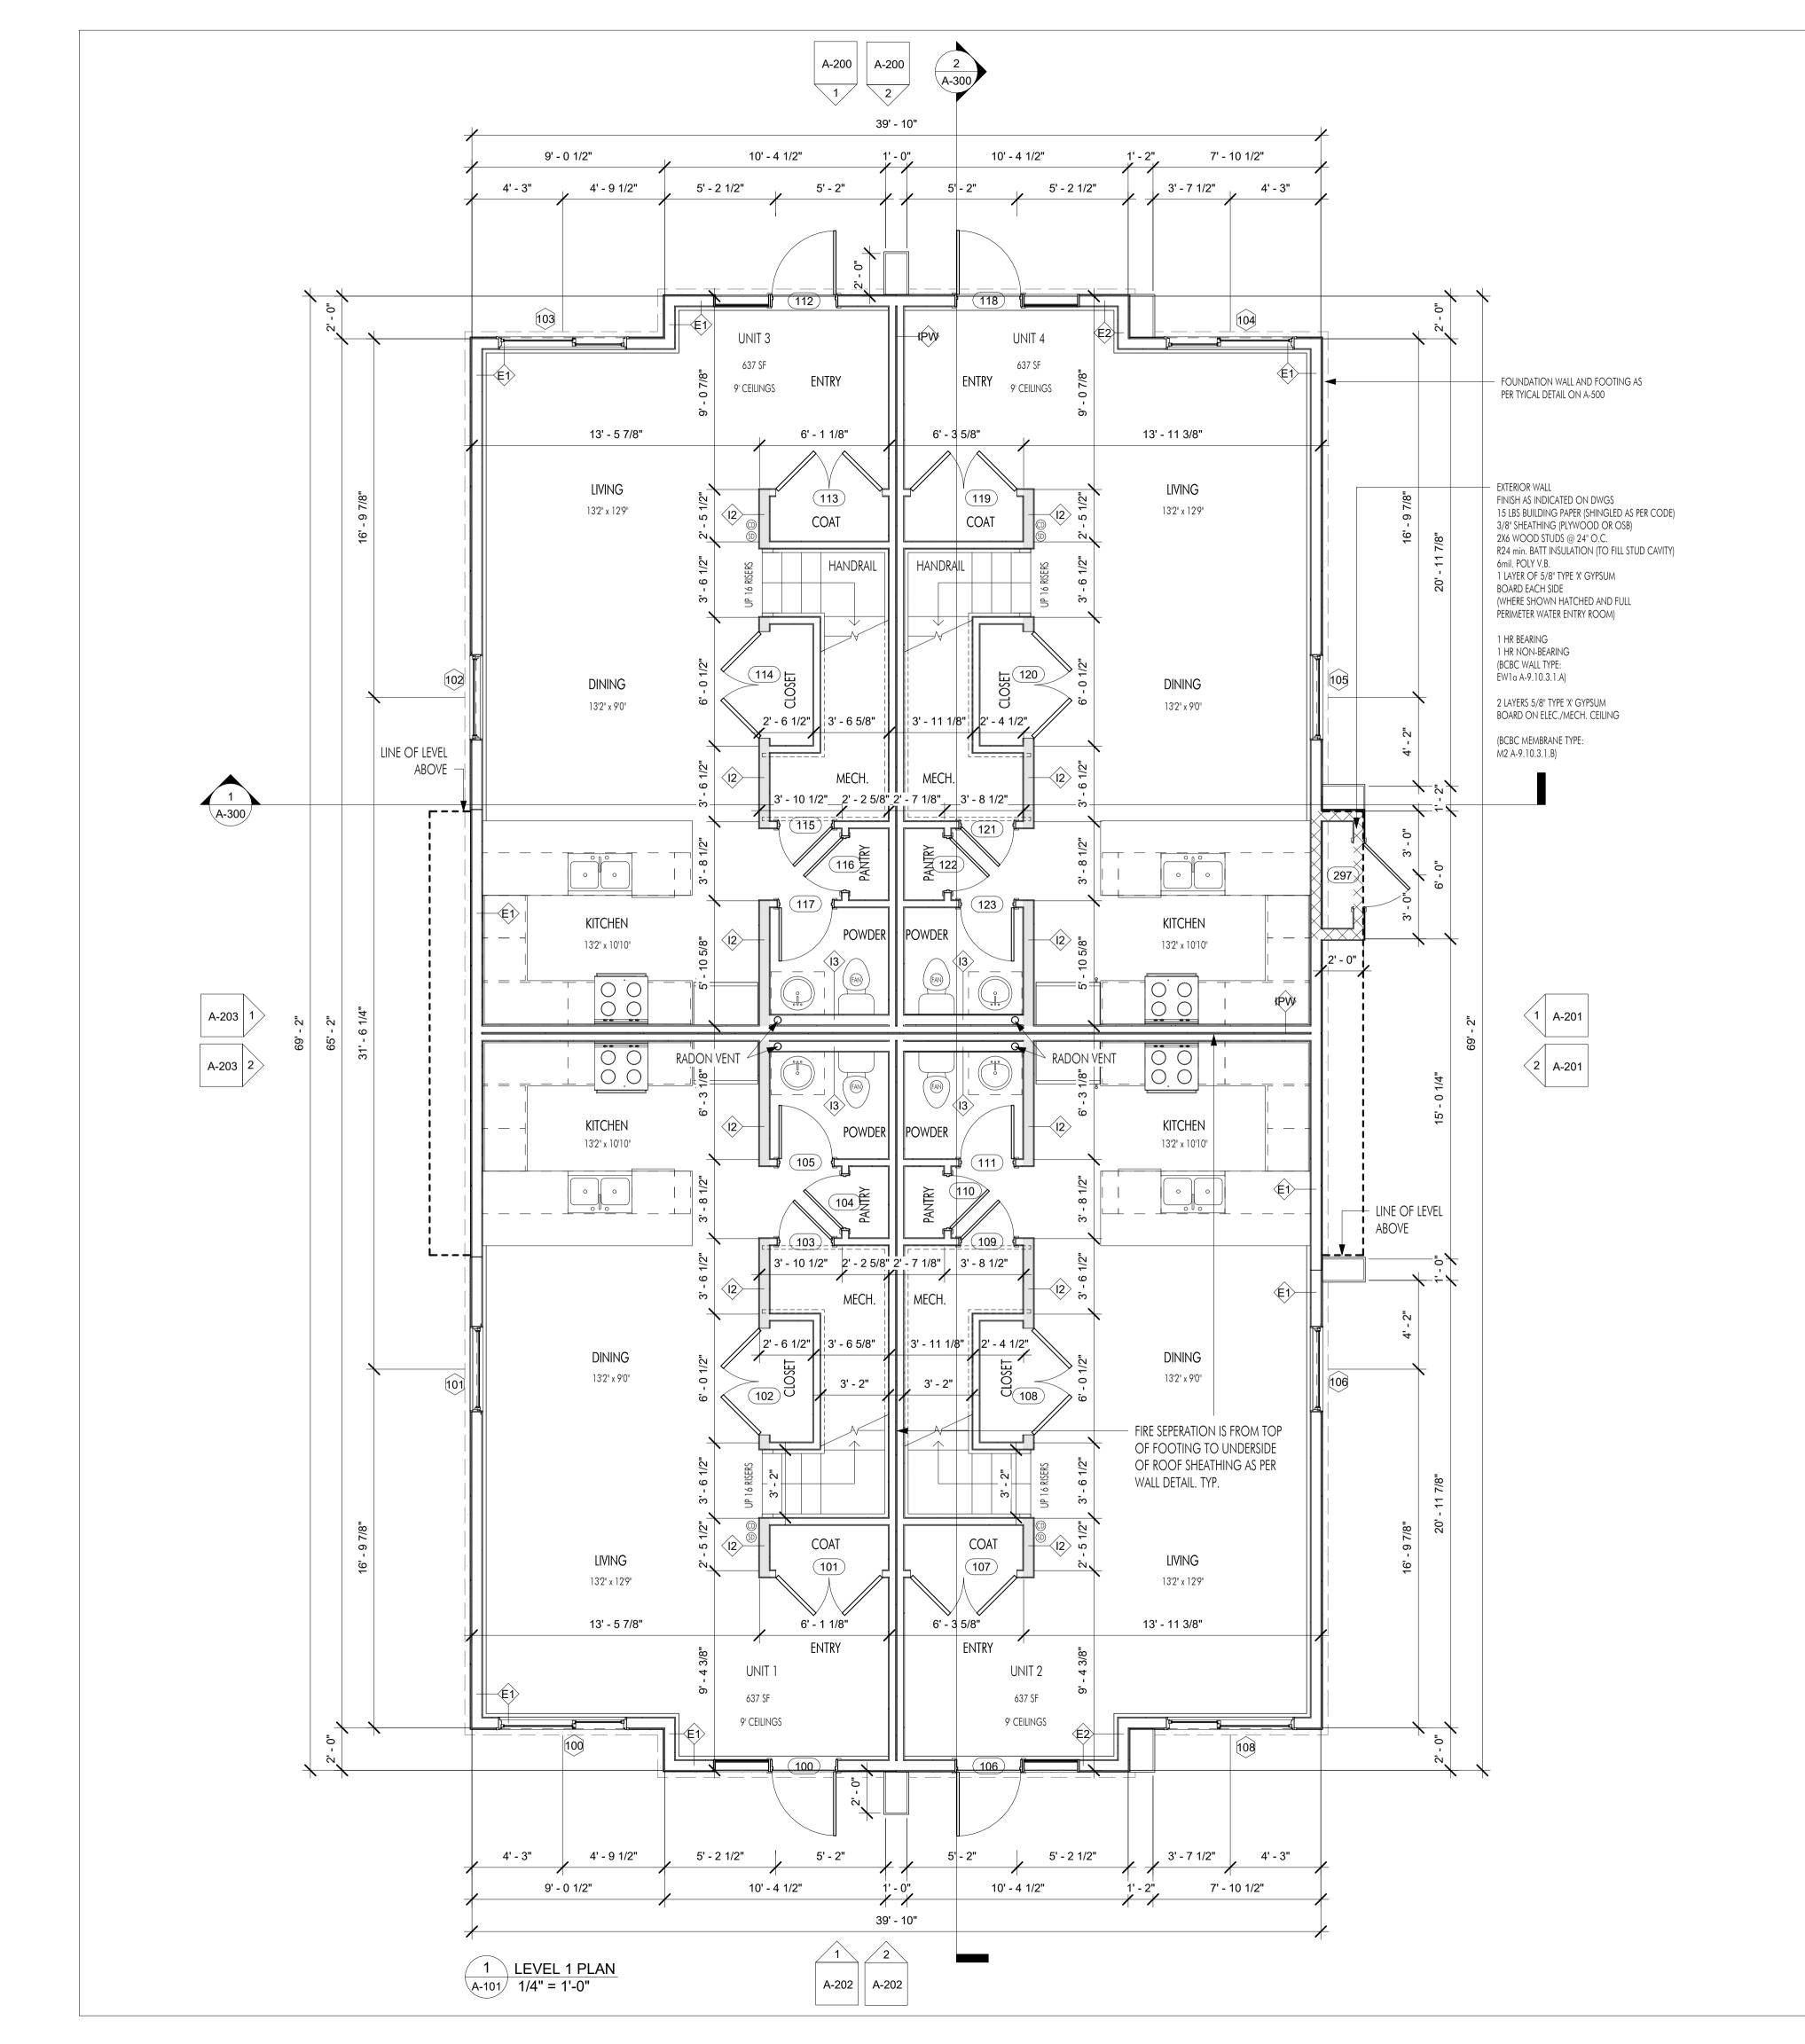

			l	_evel 1 Door S	scnedule	
Door #	Width	Height	Operation	Req. Fire Rating	Hardware	Comments
100	36"	96"	Single Swing, Glass			WITH 2'6" x 8'0" SIDELITE. C/W SWEEF AND WEATHER STRIPPING
101	60"	80"	Double Swing, Wood			
102	60"	80"	Double Swing, Wood			
103	30"	80"	Single Swing, Wood			
104	30"	80"	Single Swing, Wood			
105	30"	80"	Single Swing, Wood			
106	36"	96"	Single Swing, Glass			WITH 2'6" x 8'0" SIDELITE. C/W SWEEF AND WEATHER STRIPPING
107	60"	80"	Double Swing, Wood			
108	60"	80"	Double Swing, Wood			
109	30"	80"	Single Swing, Wood			
110	30"	80"	Single Swing, Wood			
111	30"	80"	Single Swing, Wood			
112	36"	96"	Single Swing, Glass			WITH 2'6" x 8'0" SIDELITE. C/W SWEEF AND WEATHER STRIPPING
113	60"	80"	Double Swing, Wood			
114	60"	80"	Double Swing, Wood			
115	30"	80"	Single Swing, Wood			
116	30"	80"	Single Swing, Wood			
117	30"	80"	Single Swing, Wood			
118	36"	96"	Single Swing, Glass			WITH 2'6" x 8'0" SIDELITE. C/W SWEEF AND WEATHER STRIPPING
119	60"	80"	Double Swing, Wood			
120	60"	80"	Double Swing, Wood			
121	30"	80"	Single Swing, Wood			
122	30"	80"	Single Swing, Wood			
123	30"	80"	Single Swing, Wood			

Level 1 Window Schedule						
Window #	Width	Height	Sill Height	Head Height	Operation	Comments
100	72"	72"	24"	96"	GLIDER	
101	48"	48"	48"	96"	CASEMENT	
102	48"	48"	48"	96"	CASEMENT	
103	72"	72"	24"	96"	GLIDER	
104	72"	72"	24"	96"	GLIDER	
105	48"	48"	48"	96"	CASEMENT	
106	48"	48"	48"	96"	CASEMENT	
108	72"	72"	24"	96"	GLIDER	

#### **INTERIOR DOORS:**

DOOR ROUGH OPENINGS VERSUS ACTUAL DOOR DIMENSIONS AS FOLLOWS (CONFIRM WITH MANUFACTURER):

DOOR TYPE ADDITIONAL HEIGHT ADDITIONAL WIDTH

STANDARD SINGLE SWING: +2-1/2"

BI-FOLD: +1-1/2" +1-1/4"

BYPASS (WITH GLASS DOORS): +1-1/2" +1-1/4" BYPASS (WITHOUT GLASS): +1-1/2" +0 (DOOR WIDTH)

#### WINDOWS/EXTERIOR DOORS:

WINDOW ROUGH OPENINGS VERSUS ACTUAL WINDOW/DOOR DIMENSIONS AS FOLLOWS (CONFIRM WITH MANUFACTURER):

ADDITIONAL HEIGHT ADDITIONAL WIDTH

STANDARD EXTERIOR WINDOW: +1/2" +1/2" SLIDING EXTERIOR DOORS: +1/2" +1/2" STANDARD EXTERIOR DOOR: +1"

NOTE: ALL INTERIOR WALLS TO BE 11 U.N.O.

205-1626 Richter Street, Kelowna, BC V1Y 2M3 www.limearchitecture.com

PHONE:250-448-7801

COPYRIGHT. ALL RIGHTS RESERVED

All ideas, designs, drawings and specifications are the exclusive property of LIME Architecture Inc. As instruments of service, they may not be used or reproduced in any manner without the expressed written consent of LIME Architecture Inc. All Contracting Trades shall check and verify all levels, dimensions, data and conditions on the site prior to commencement of any work. Any discrepancies are to be reported immediately to LIME Architecture Inc. Do not Scale any dimensions from this drawing.

All trades are to execute the work in accordance with the current municipality building by-laws and requirements of other local authorities having jurisdiction as well as the british columbia building code -(most recent edition) including all published revisions and addenda. All trades shall assume full responsiblity for the locations and protection of all under and above ground utilities, wires and conduit connections, including (but not limited to) water, sewer, gas, hydro and telephone.

**Revision No., Date** and Description

07.27.23 FOR COORDINATION 10.03.23 FOR DP


Plot Date 10.03.23


**PROJECT** 1016 MARTIN AVE

DRAWING TITLE

LEVEL 1 PLAN

Drawing No.

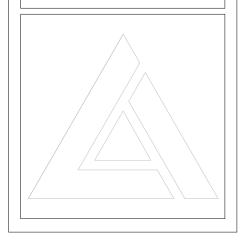

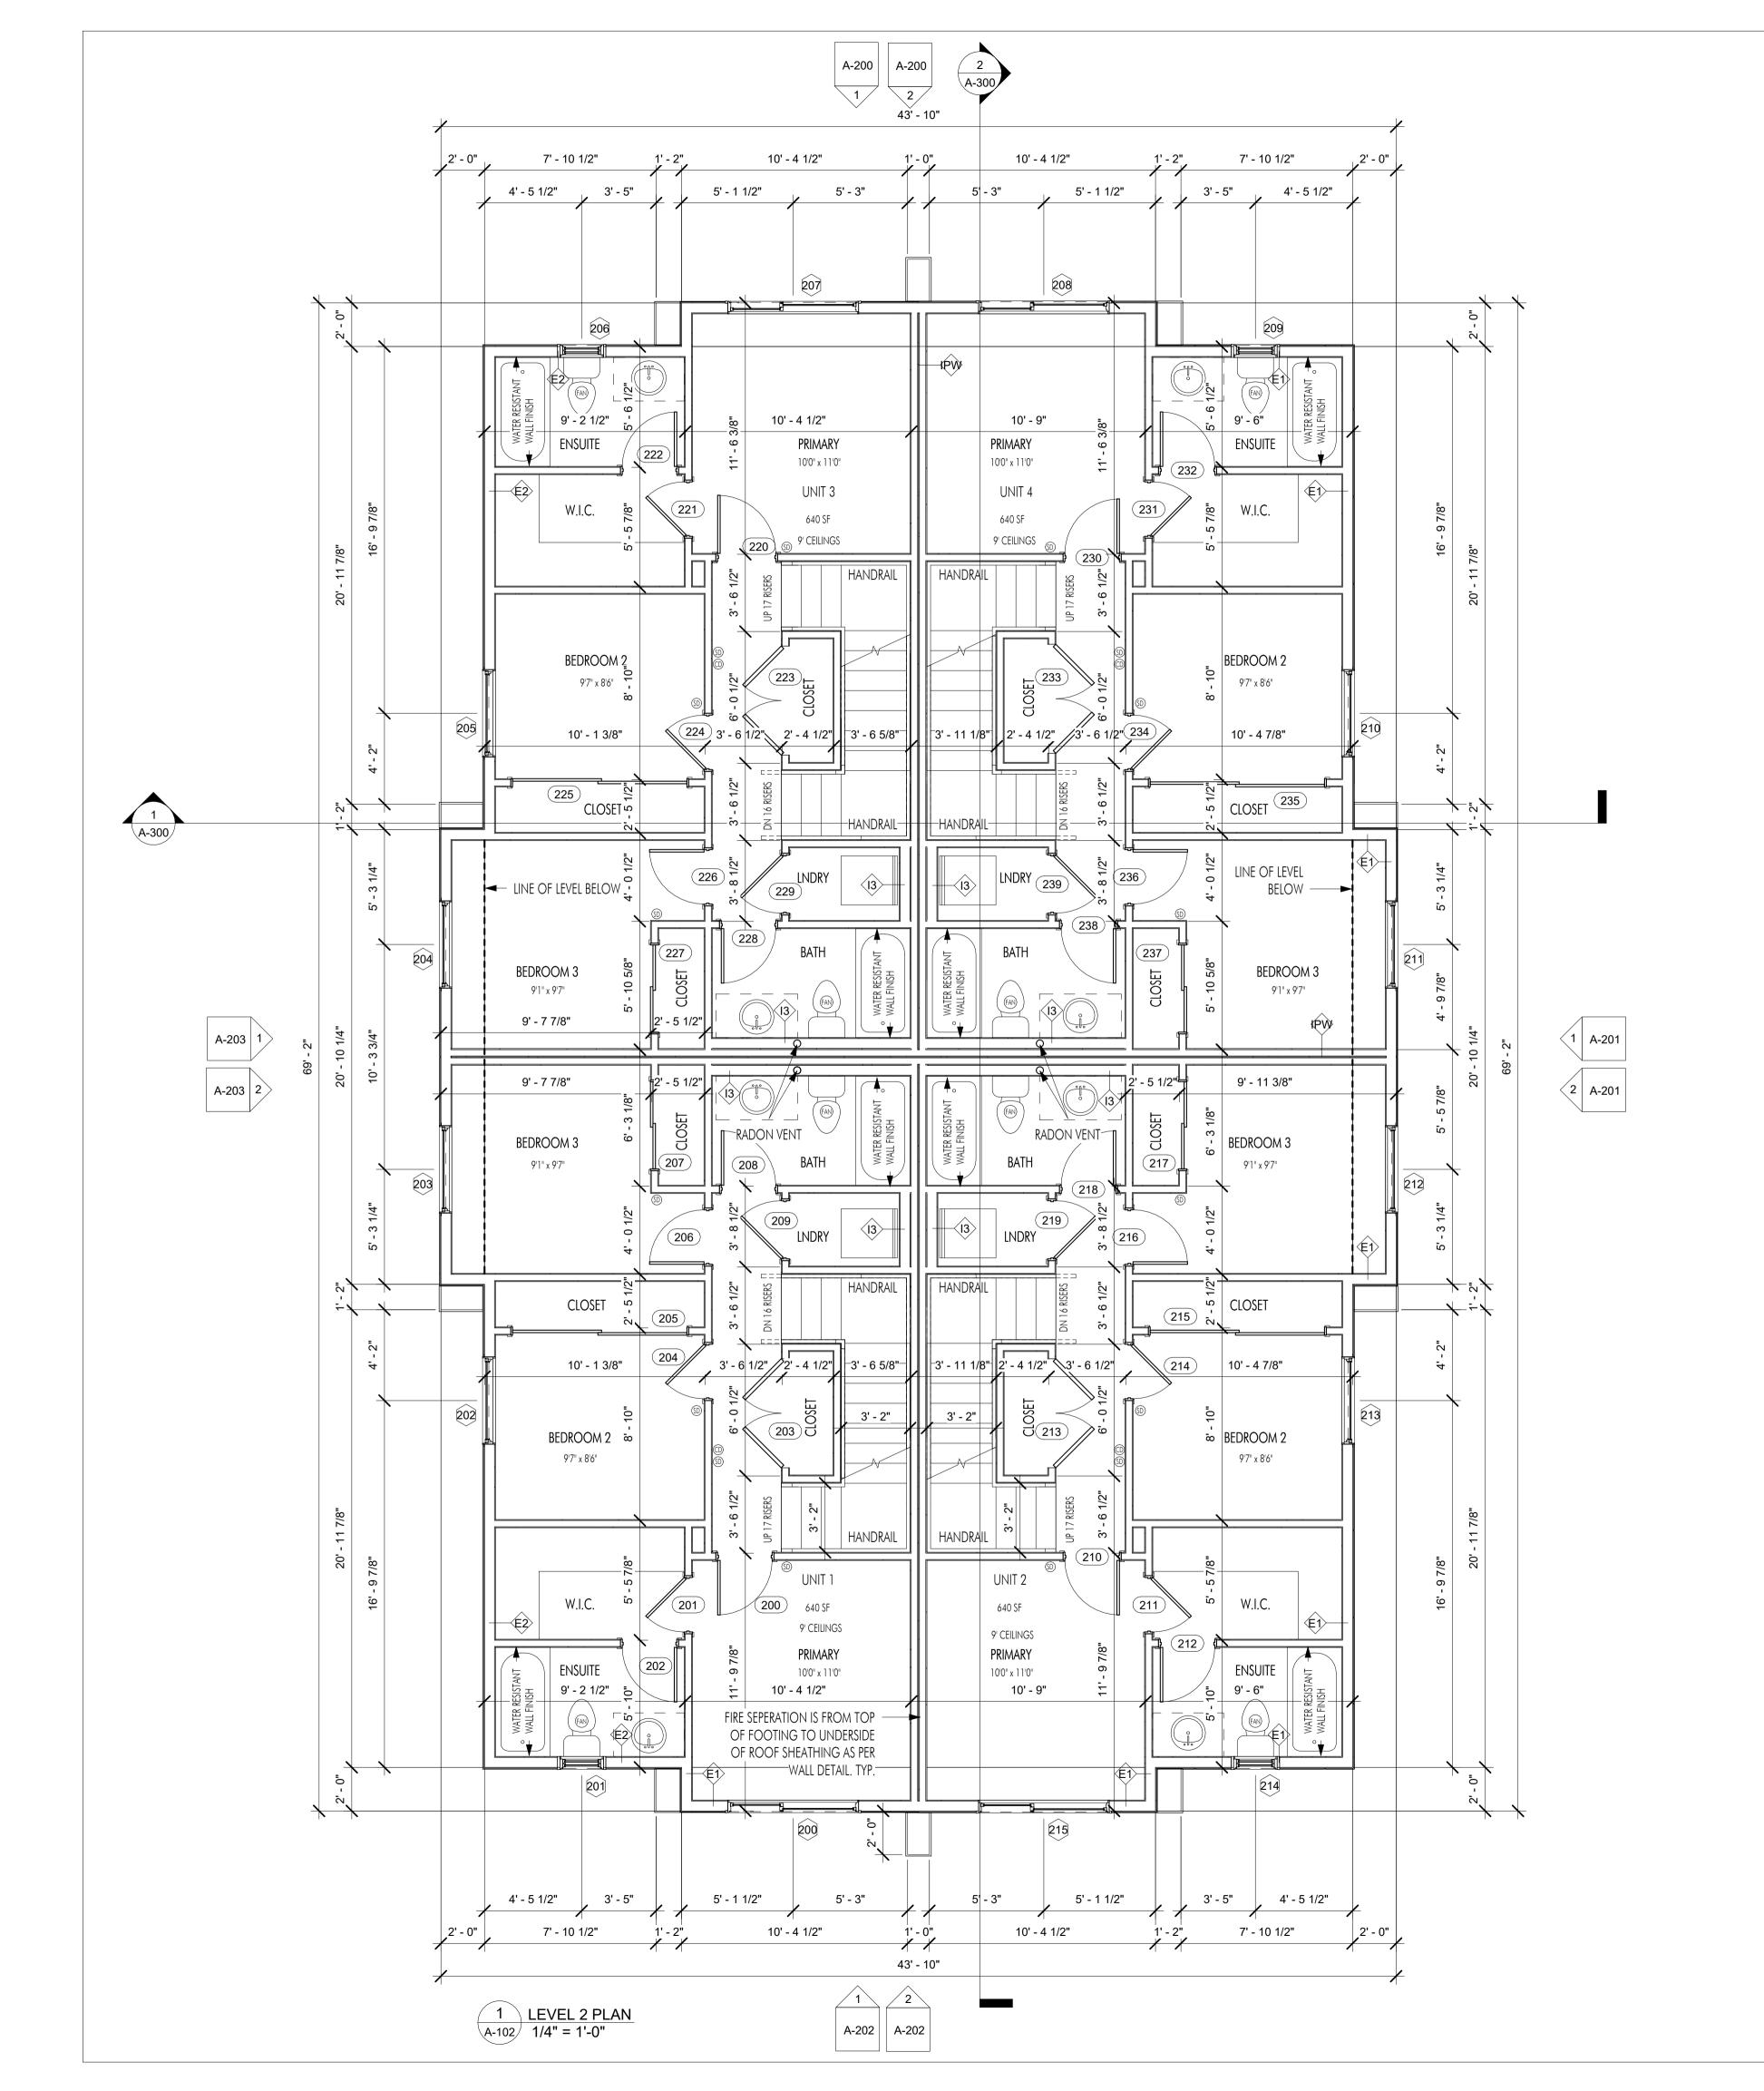

D	VA (* -141-	11.5.1.4	Oti	Req. Fire		
Door #	Width	Height	Operation	Rating	Hardware	Comments
200	30"	80"	Single Swing, Wood			
201	30"	80"	Single Swing, Wood			
202	30"	80"	Single Swing, Wood			
203	60"	80"	Double Swing, Wood			
204	30"	80"	Single Swing, Wood			
205	96"	80"	Sliding Double, Wood			
206	30"	80"	Single Swing, Wood			
207	48"	80"	Sliding Double, Wood			
208	30"	80"	Single Swing, Wood			
209	32"	80"	Single Swing, Wood			
210	30"	80"	Single Swing, Wood			
211	30"	80"	Single Swing, Wood			
212	30"	80"	Single Swing, Wood			
213	60"	80"	Double Swing, Wood			
214	30"	80"	Single Swing, Wood			
215	96"	80"	Sliding Double, Wood			
216	30"	80"	Single Swing, Wood			
217	48"	80"	Sliding Double, Wood			
218	30"	80"	Single Swing, Wood			
219	32"	80"	Single Swing, Wood			
220	32"	80"	Single Swing, Wood			
221	30"	80"	Single Swing, Wood			
222	30"	80"	Single Swing, Wood			
223	60"	80"	Double Swing, Wood			
224	30"	80"	Single Swing, Wood			
225	96"	80"	Sliding Double, Wood			
226	30"	80"	Single Swing, Wood			
227	48"	80"	Sliding Double, Wood			
228	30"	80"	Single Swing, Wood			
229	32"	80"	Single Swing, Wood			
230	30"	80"	Single Swing, Wood			
231	30"	80"	Single Swing, Wood			
232	30"	80"	Single Swing, Wood			
233	60"	80"	Double Swing, Wood			
	30"	80"	-			
234	96"	80"	Single Swing, Wood			
235			Sliding Double, Wood			
236	30"	80"	Single Swing, Wood			
237	48"	80"	Sliding Double, Wood			
238	30"	80"	Single Swing, Wood			
239	32"	80"	Single Swing, Wood			
297	36"	80"	Single Swing, Wood			

Level 1 Window Schedule							
Window #	Width	Height	Sill Height	Head Height	Operation	Comments	
100	72"	72"	24"	96"	GLIDER		
101	48"	48"	48"	96"	CASEMENT		
102	48"	48"	48"	96"	CASEMENT		
103	72"	72"	24"	96"	GLIDER		
104	72"	72"	24"	96"	GLIDER		
105	48"	48"	48"	96"	CASEMENT		
106	48"	48"	48"	96"	CASEMENT		
108	72"	72"	24"	96"	GLIDER		

#### INTERIOR DOORS:

DOOR ROUGH OPENINGS VERSUS ACTUAL DOOR DIMENSIONS AS FOLLOWS (CONFIRM WITH MANUFACTURER):

DOOR TYPE ADDITIONAL HEIGHT ADDITIONAL WIDTH

STANDARD SINGLE SWING: +2-1/2" +2"

BI-FOLD: +1-1/2" +1-1/4"

BYPASS (WITH GLASS DOORS): +1-1/2" +1-1/4" BYPASS (WITHOUT GLASS): +1-1/2" +0 (DOOR WIDTH)

WINDOWS/EXTERIOR DOORS:

WINDOW ROUGH OPENINGS VERSUS ACTUAL WINDOW/DOOR DIMENSIONS AS FOLLOWS (CONFIRM WITH MANUFACTURER):

TYPE ADDITIONAL HEIGHT ADDITIONAL WIDTH

STANDARD EXTERIOR WINDOW: +1/2" +1/2"

SLIDING EXTERIOR DOORS: +1/2" +1/2"

STANDARD EXTERIOR DOOR: +1" +1"

NOTE: ALL INTERIOR WALLS TO BE 11 U.N.O.

ARCHITECTUR

205-1626 Richter Street, Kelowna, BC V1Y 2M3 www.limearchitecture.com

PHONE:250-448-7801

COPYRIGHT.
ALL RIGHTS RESERVED

All ideas, designs, drawings and specifications are the exclusive property of LIME Architecture Inc. As instruments of service, they may not be used or reproduced in any manner without the expressed written consent of LIME Architecture Inc. All Contracting Trades shall check and verify all levels, dimensions, data and conditions on the site prior to commencement of any work. Any discrepancies are to be reported immediately to LIME Architecture Inc. Do not Scale any dimensions from this drawing.

All trades are to execute the work in accordance with the current municipality building by-laws and requirements of other local authorities having jurisdiction as well as the british columbia building code - (most recent edition) including all published revisions and addenda. All trades shall assume full responsibility for the locations and protection of all under and above ground utilities, wires and conduit connections, including (but not limited to) water, sewer, gas, hydro and telephone.

Revision No., Date and Description

07.27.23 FOR COORDINATION 10.03.23 FOR DP


Plot Date 10.03.23


PROJECT 1016 MARTIN AVE

DRAWING TITLE

LEVEL 2 PLAN

Drawing No.

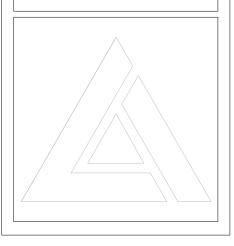

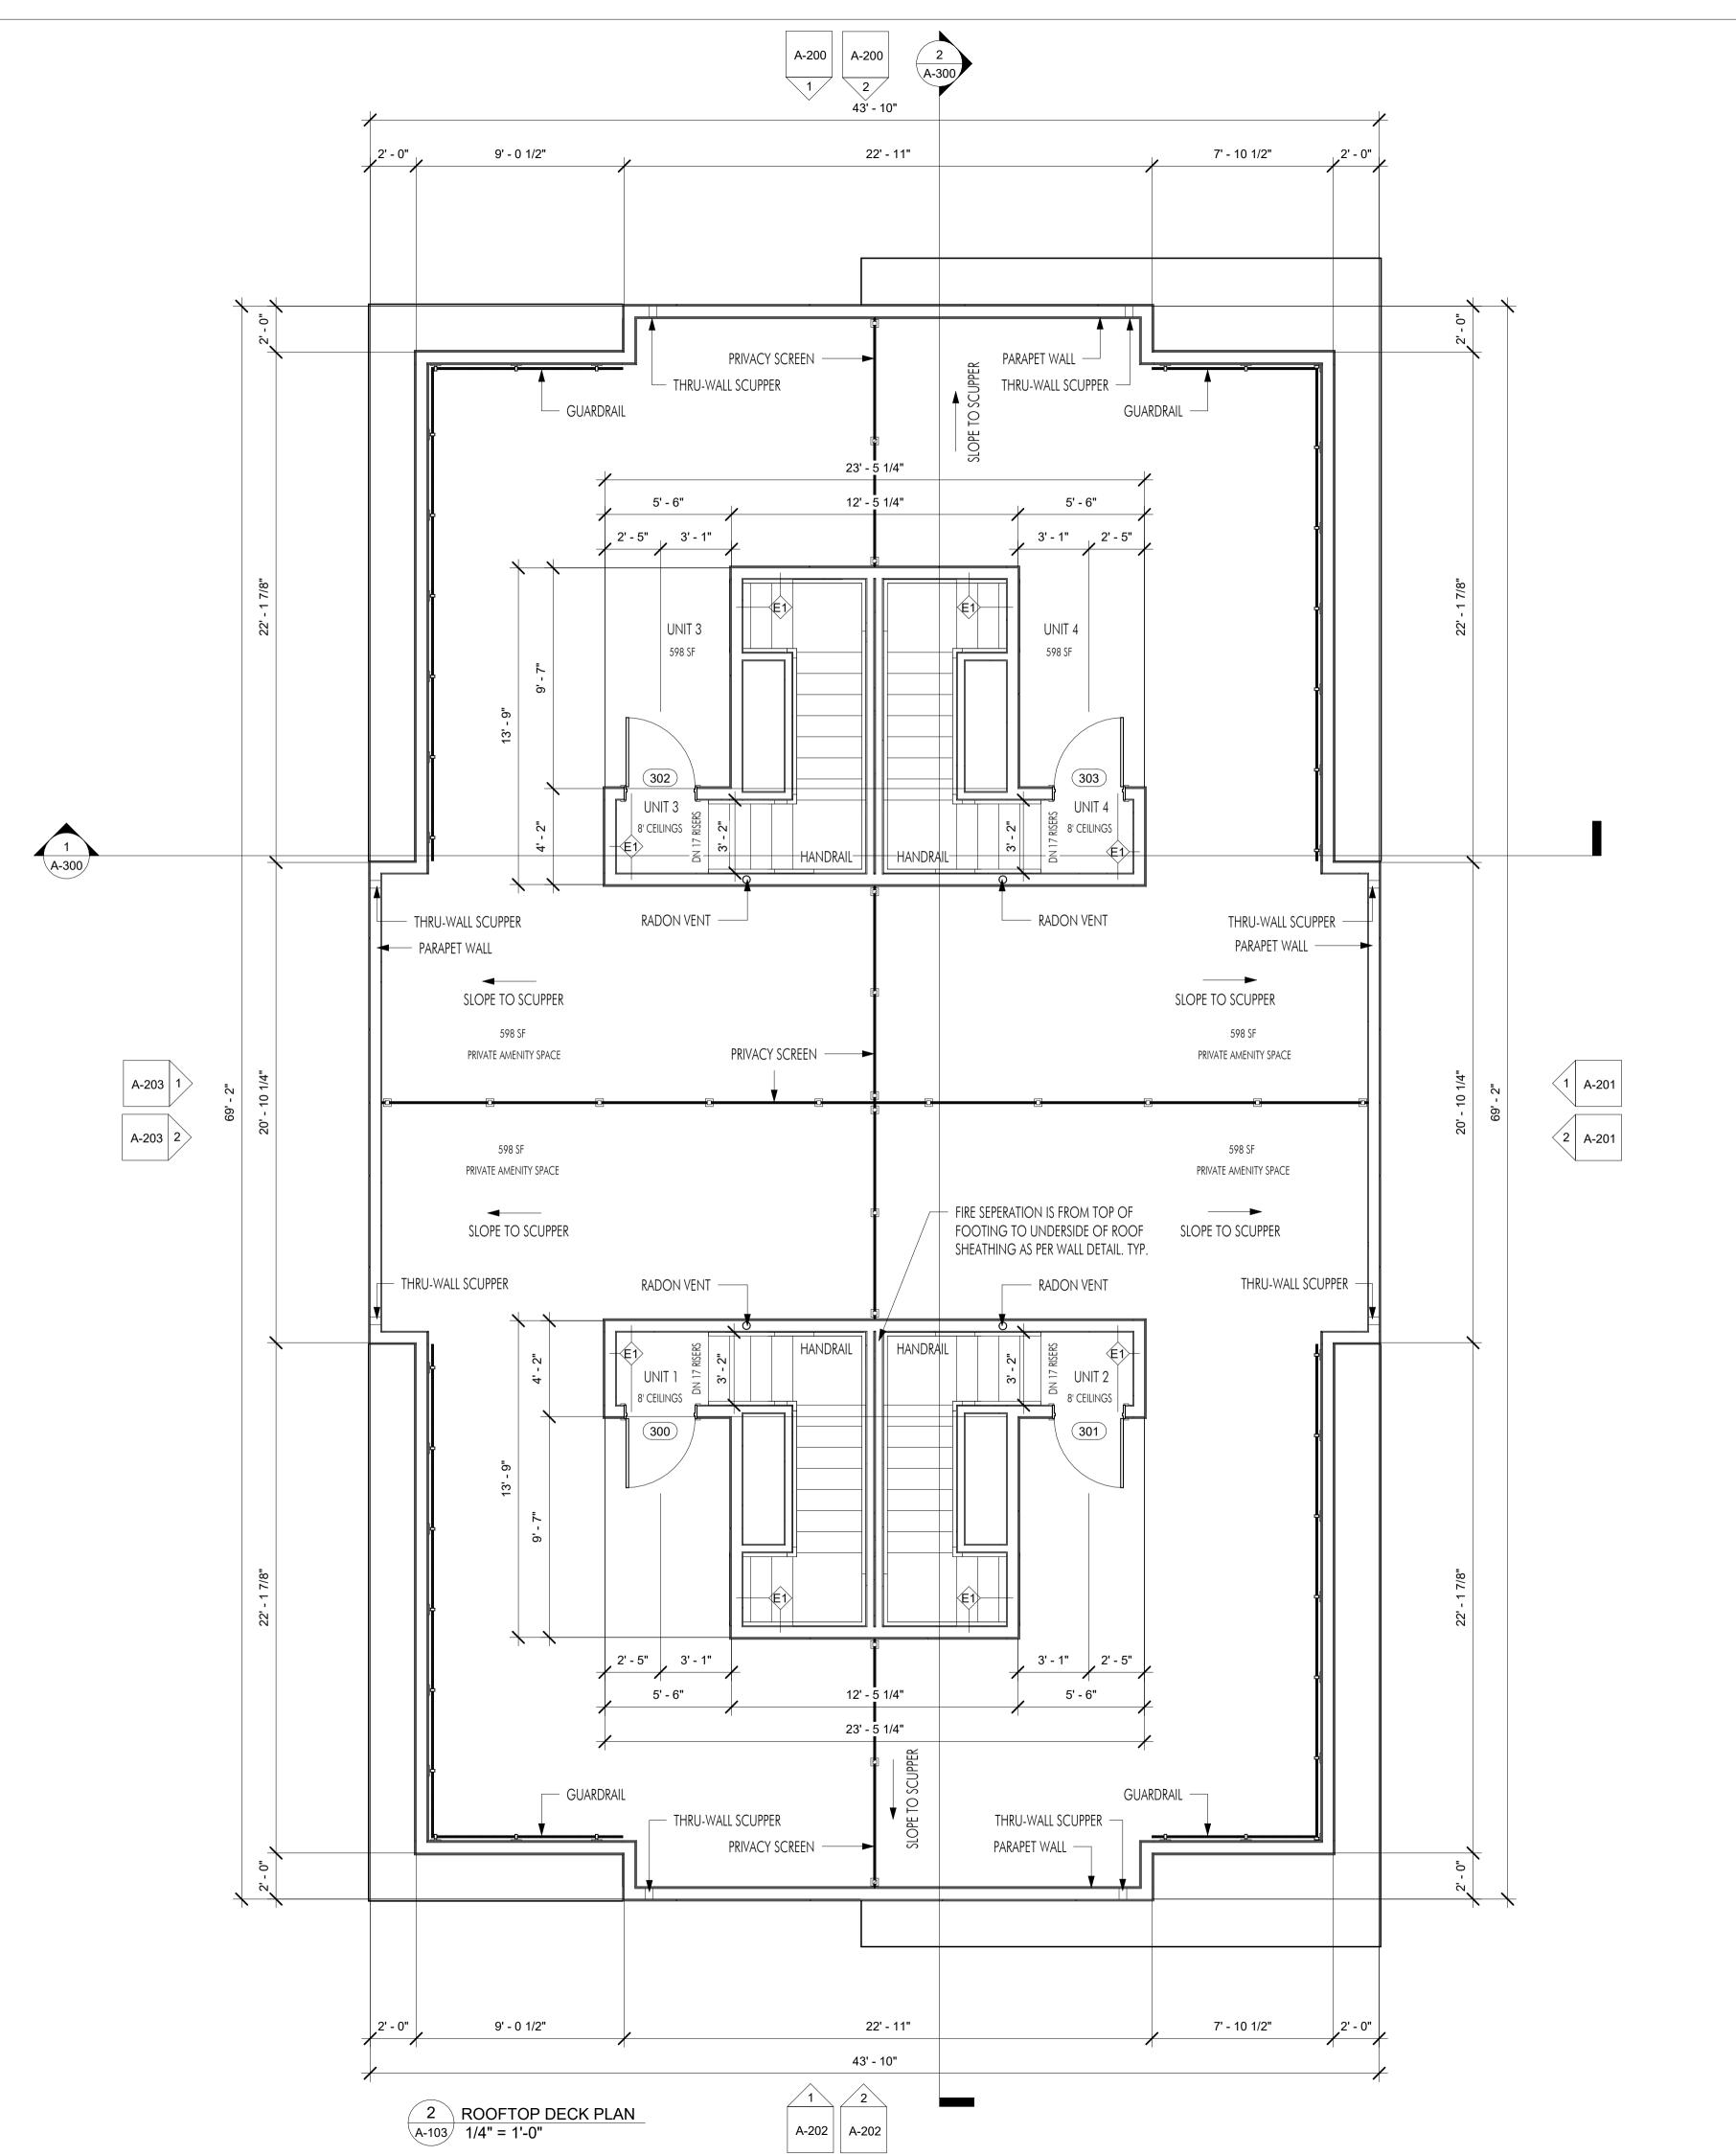

Rooftop Deck Door Schedule							
Door #	Width	Height	Operation	Req. Fire Rating	Hardware	Comments	
300	36"	80"	Single Swing, Glass			C/W SWEEP AND WEATHER STRIPPING	
301	36"	80"	Single Swing, Glass			C/W SWEEP AND WEATHER STRIPPING	
302	36"	80"	Single Swing, Glass			C/W SWEEP AND WEATHER STRIPPING	
303	36"	80"	Single Swing, Glass			C/W SWEEP AND WEATHER STRIPPING	

#### **INTERIOR DOORS:**

DOOR ROUGH OPENINGS VERSUS ACTUAL DOOR DIMENSIONS AS FOLLOWS (CONFIRM WITH MANUFACTURER):

DOOR TYPE ADDITIONAL HEIGHT ADDITIONAL WIDTH STANDARD SINGLE SWING: +2-1/2"


BI-FOLD: +1-1/2" +1-1/4" BYPASS (WITH GLASS DOORS): +1-1/2" +1-1/4" BYPASS (WITHOUT GLASS): +0 (DOOR WIDTH)

#### WINDOWS/EXTERIOR DOORS:

WINDOW ROUGH OPENINGS VERSUS ACTUAL WINDOW/DOOR DIMENSIONS AS FOLLOWS (CONFIRM WITH MANUFACTURER):

<u>TYPE</u>	ADDITIONAL HEIGHT	ADDITIONAL WIDTH
STANDARD EXTERIOR WINDOW:	+1/2"	+1/2"
SLIDING EXTERIOR DOORS:	+1/2"	+1/2"
STANDARD EXTERIOR DOOR:	+1"	+1"

NOTE: ALL INTERIOR WALLS TO BE 11 U.N.O.

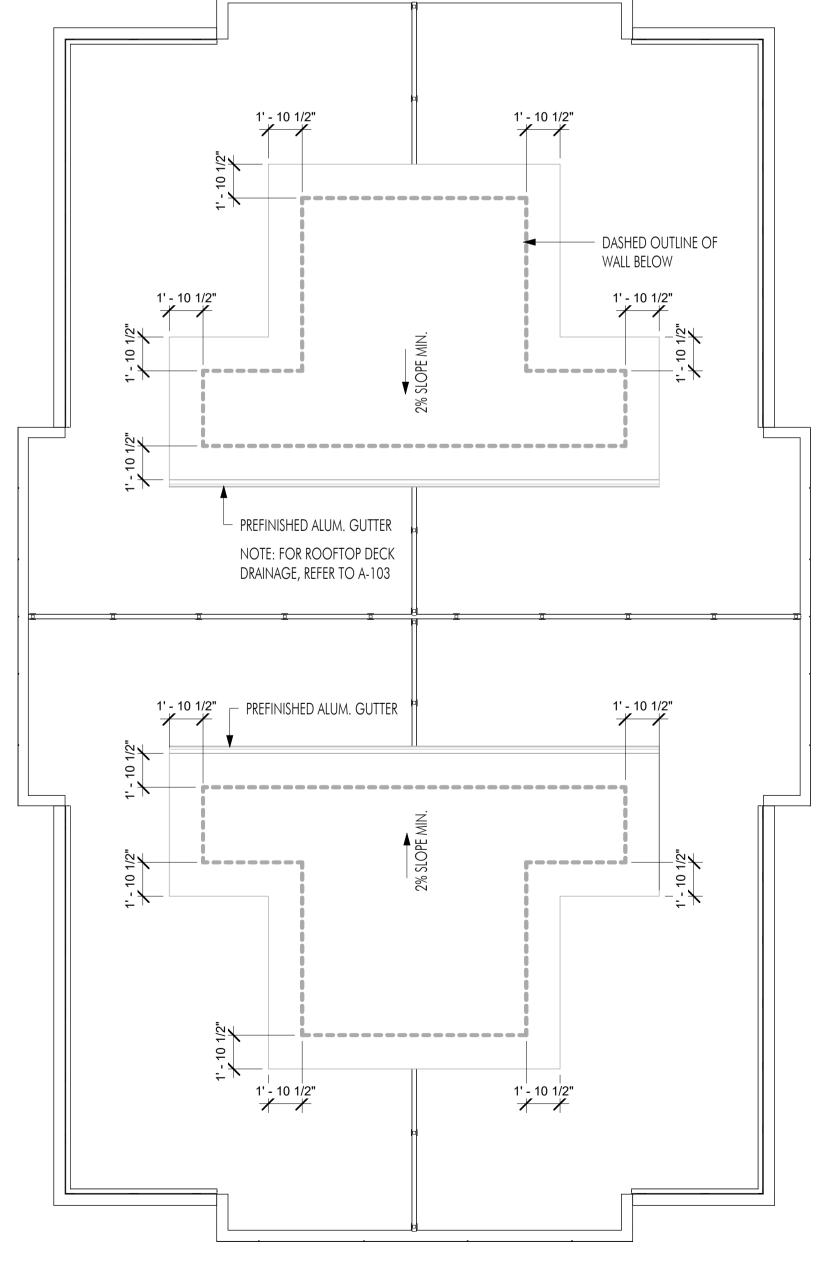

1 ROOF PLAN A-103 3/16" = 1'-0"

PHONE:250-448-7801

205-1626 Richter Street, Kelowna, BC V1Y 2M3 www.limearchitecture.com

COPYRIGHT. ALL RIGHTS RESERVED

All ideas, designs, drawings and specifications are the exclusive property of LIME Architecture Inc. As instruments of service, they may not be used or reproduced in any manner without the expressed written consent of LIME Architecture Inc. All Contracting Trades shall check and verify all levels, dimensions, data and conditions on the site prior to commencement of any work. Any discrepancies are to be reported immediately to LIME Architecture Inc. Do not Scale any dimensions from this drawing.

All trades are to execute the work in accordance with the current municipality building by-laws and requirements of other local authorities having jurisdiction as well as the british columbia building code -(most recent edition) including all published revisions and addenda. All trades shall assume full responsiblity for the locations and protection of all under and above ground utilities, wires and conduit connections, including (but not limited to) water, sewer, gas, hydro and telephone.


**Revision No., Date** and Description


07.27.23 FOR COORDINATION 10.03.23 FOR DP

Plot Date 10.03.23 **PROJECT** 

1016 MARTIN AVE DRAWING TITLE


ROOFTOP DECK PLAN Drawing No.

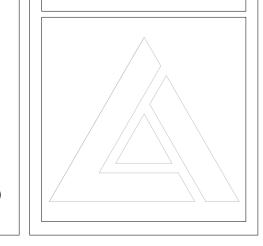


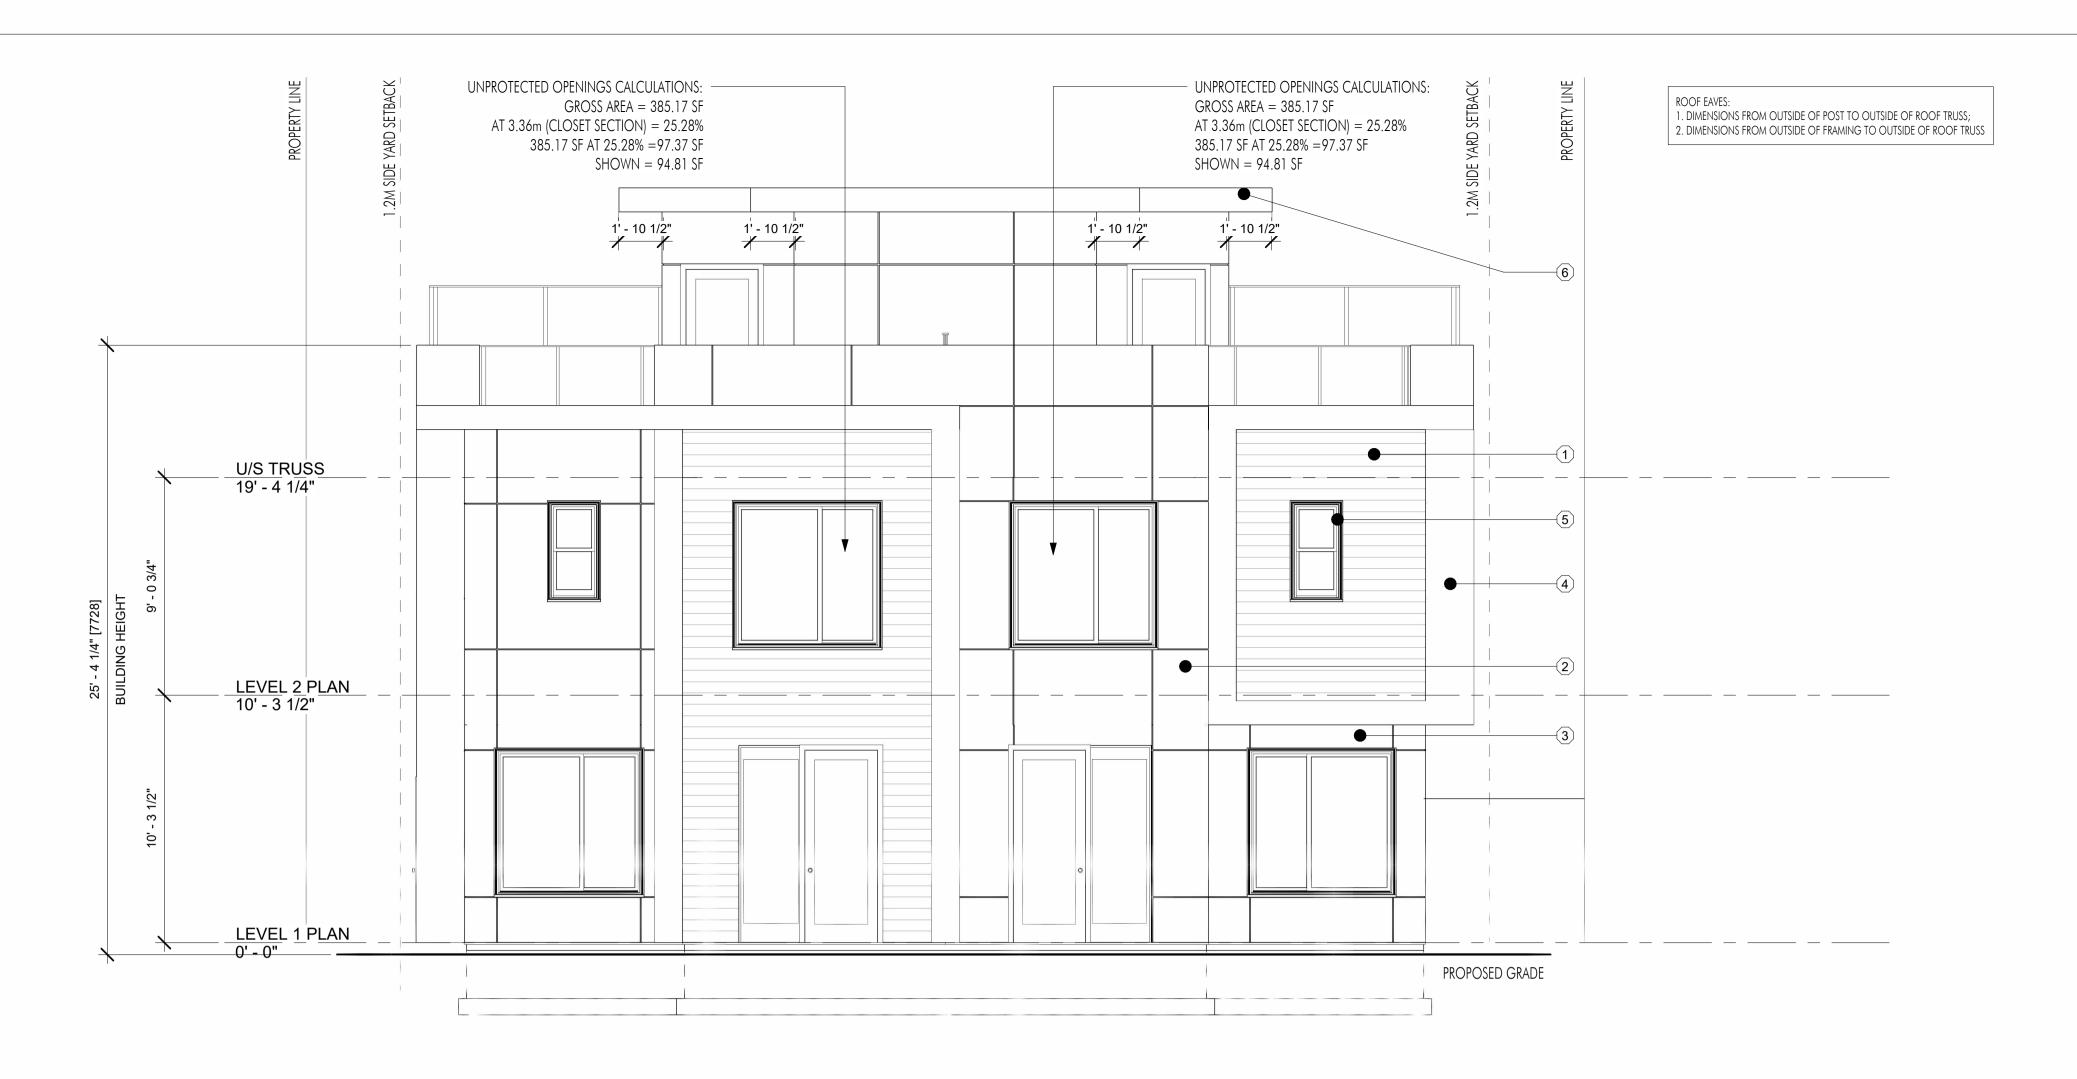

1 North Elevation A-200 1/4" = 1'-0"



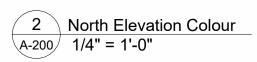

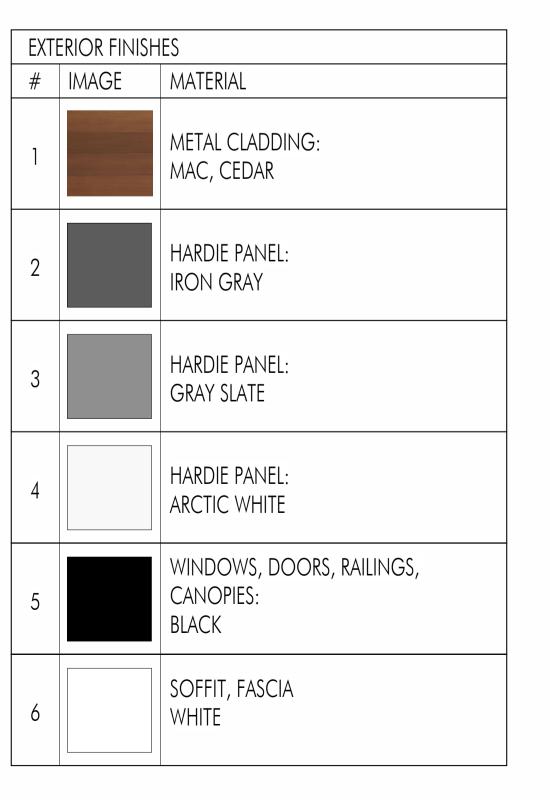

ARCHITEC

PHONE:250-448-7801

205-1626 Richter Street, Kelowna, BC V1Y 2M3 www.limearchitecture.com

COPYRIGHT.
ALL RIGHTS RESERVED

All ideas, designs, drawings and specifications are the exclusive property of LIME Architecture Inc. As instruments of service, they may not be used or reproduced in any manner without the expressed written consent of LIME Architecture Inc. All Contracting Trades shall check and verify all levels, dimensions, data and conditions on the site prior to commencement of any work. Any discrepancies are to be reported immediately to LIME Architecture Inc. Do not Scale any dimensions from this drawing.

All trades are to execute the work in accordance with the current municipality building by-laws and requirements of other local authorities having jurisdiction as well as the british columbia building code - (most recent edition) including all published revisions and addenda. All trades shall assume full responsibility for the locations and protection of all under and above ground utilities, wires and conduit connections, including (but not limited to) water, sewer, gas, hydro and telephone.

Revision No., Date and Description

07.27.23 FOR COORDINATION 10.03.23 FOR DP


Plot Date
10.03.23


PROJECT
1016 MARTIN AVE

DRAWING TITLE

ELEVATIONS

Drawing No.

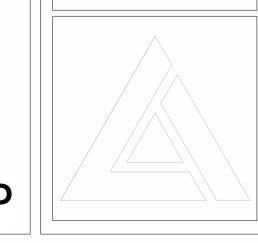

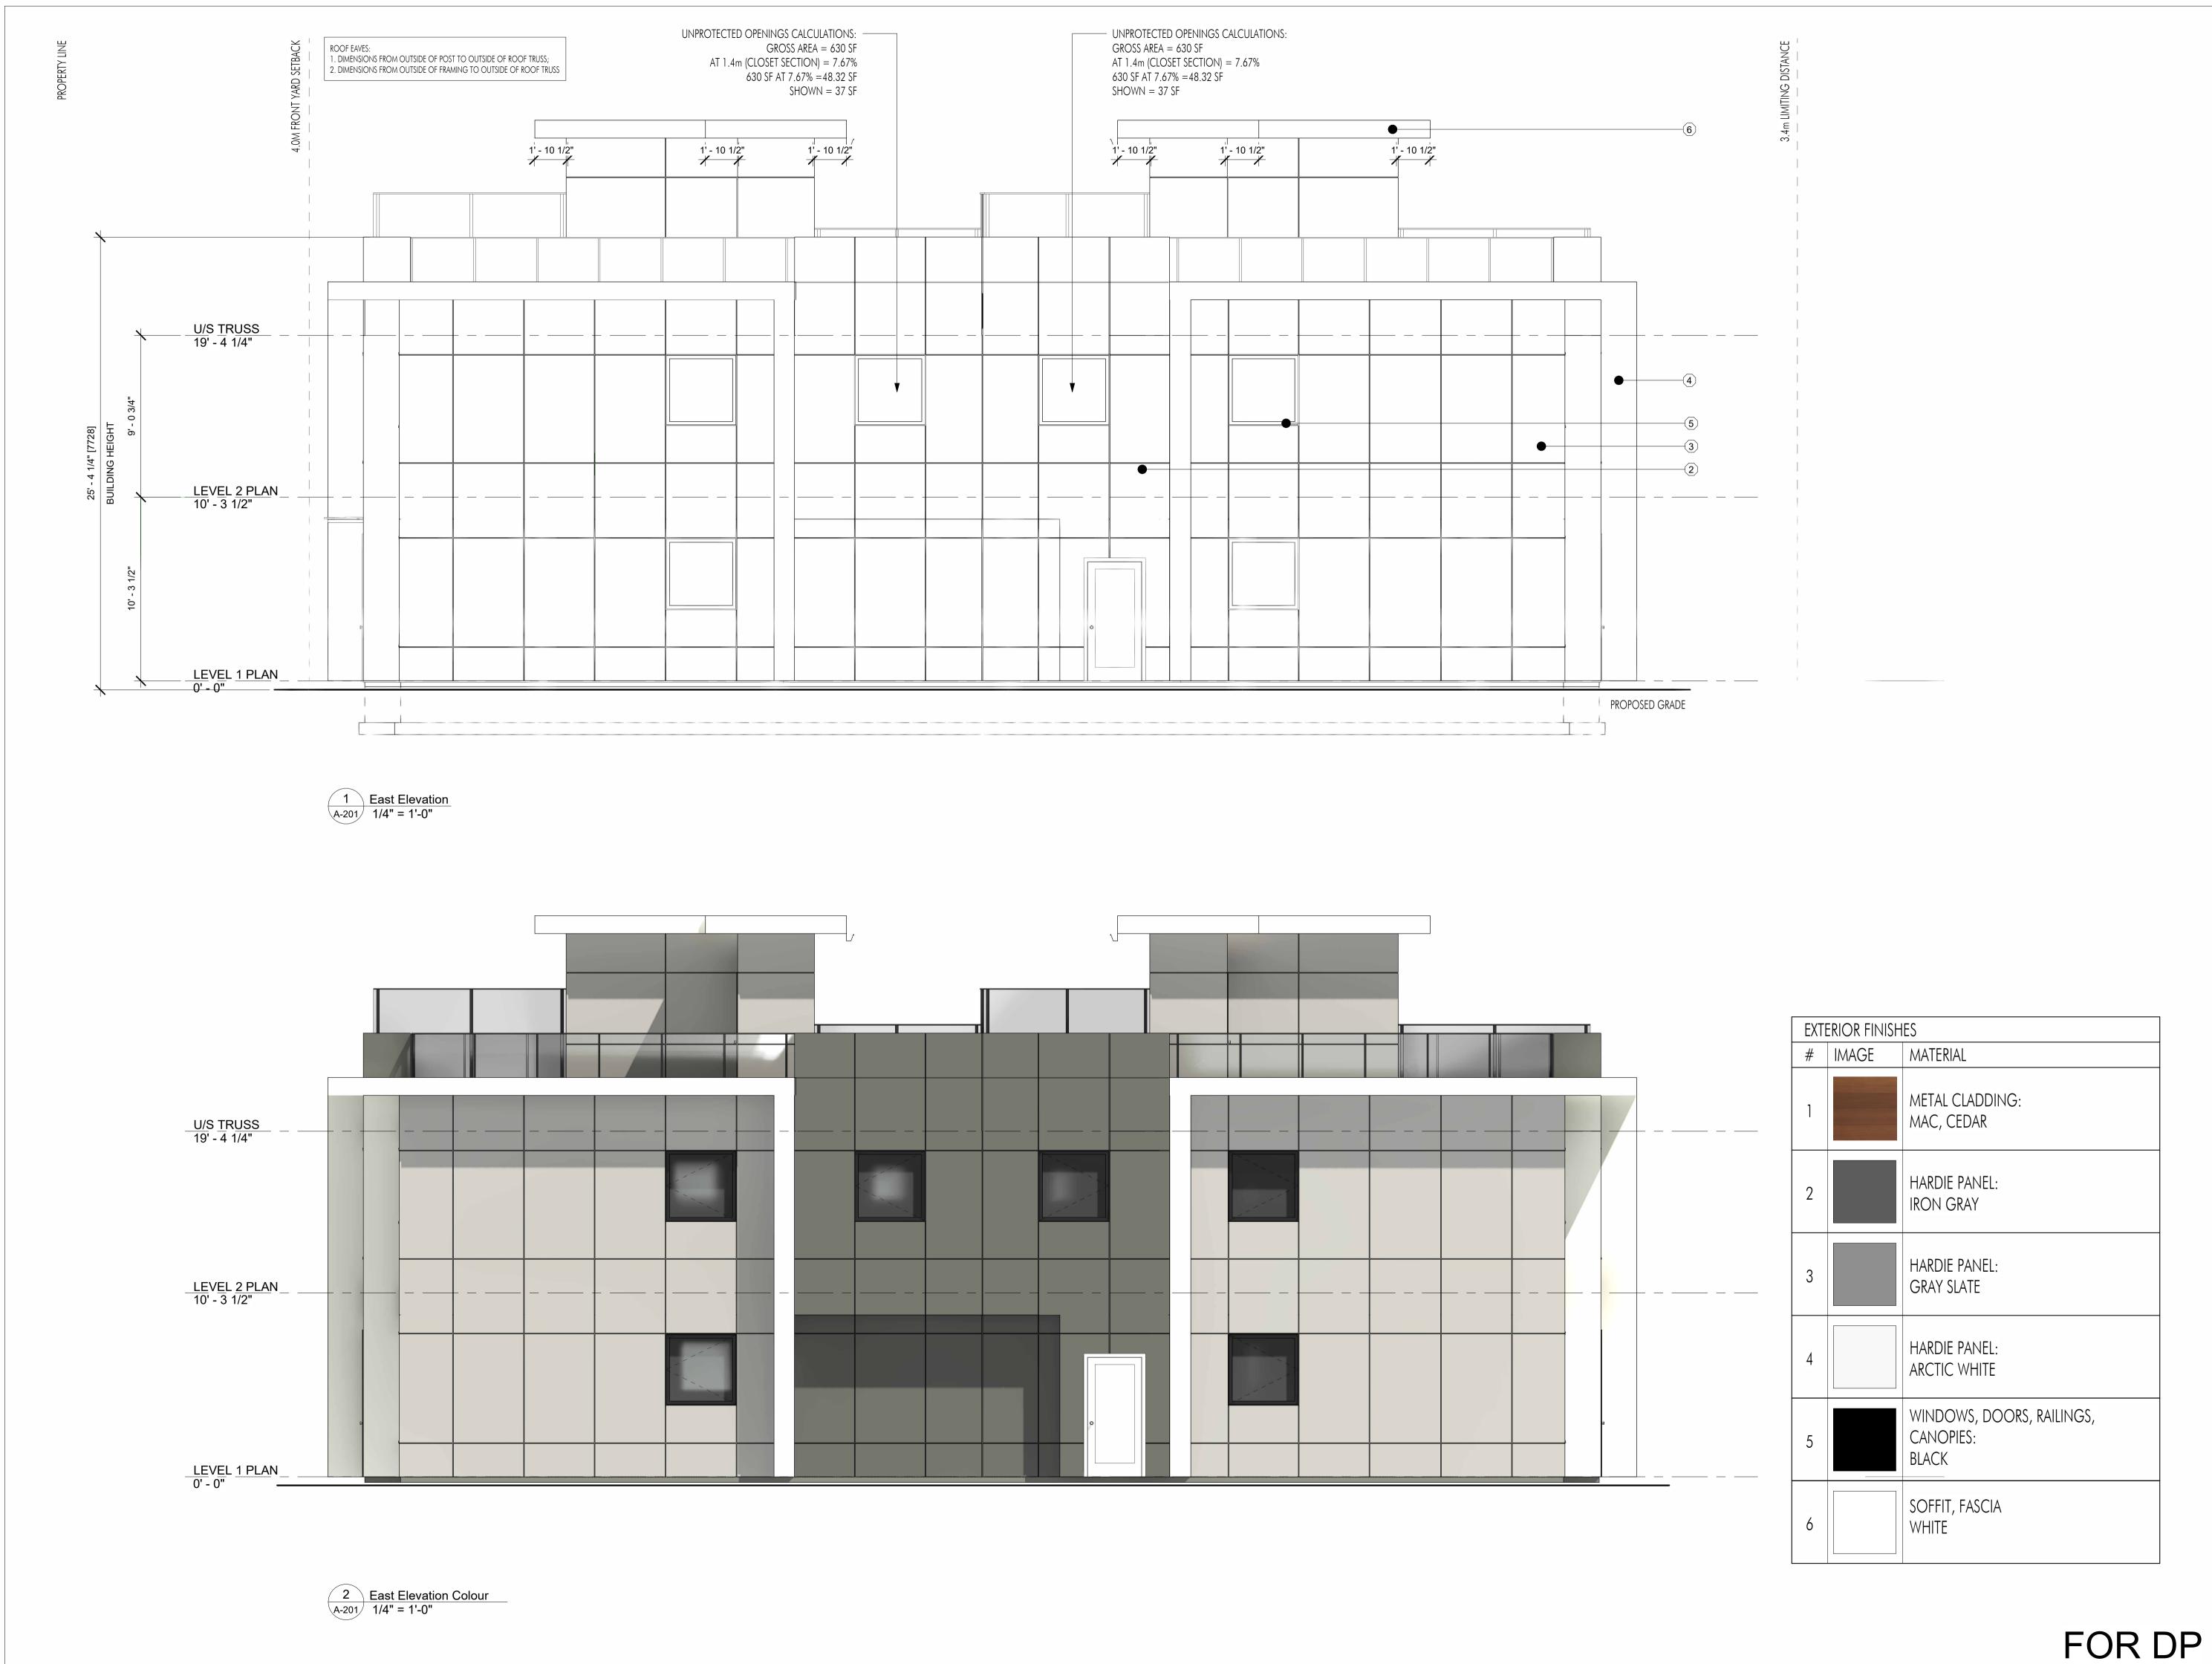

ARCHITECTU

PHONE:250-448-7801

205-1626 Richter Street, Kelowna, BC V1Y 2M3 www.limearchitecture.com

COPYRIGHT.
ALL RIGHTS RESERVED

All ideas, designs, drawings and specifications are the exclusive property of LIME Architecture Inc. As instruments of service, they may not be used or reproduced in any manner without the expressed written consent of LIME Architecture Inc. All Contracting Trades shall check and verify all levels, dimensions, data and conditions on the site prior to commencement of any work. Any discrepancies are to be reported immediately to LIME Architecture Inc. Do not Scale any dimensions from this drawing.

All trades are to execute the work in accordance with the current municipality building by-laws and requirements of other local authorities having jurisdiction as well as the british columbia building code - (most recent edition) including all published revisions and addenda. All trades shall assume full responsibility for the locations and protection of all under and above ground utilities, wires and conduit connections, including (but not limited to) water, sewer, gas, hydro and telephone.

Revision No., Date and Description


07.27.23 FOR COORDINATION 10.03.23 FOR DP

Plot Date 10.03.23 PROJECT

1016 MARTIN AVE

DRAWING TITLE
ELEVATIONS


Drawing No.

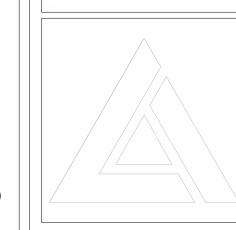







South Elevation Colour
A-202 1/4" = 1'-0"

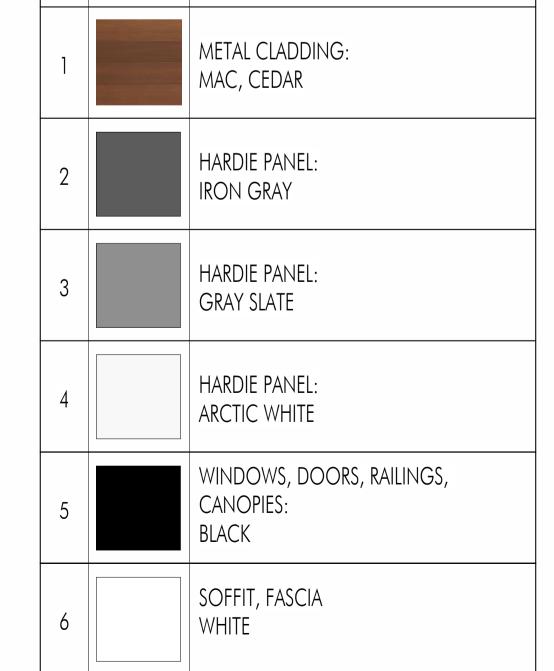


EXTERIOR FINISHES

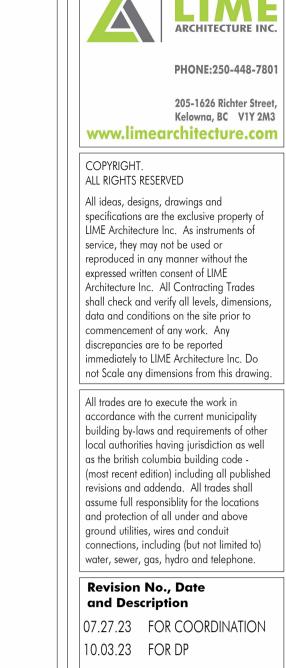

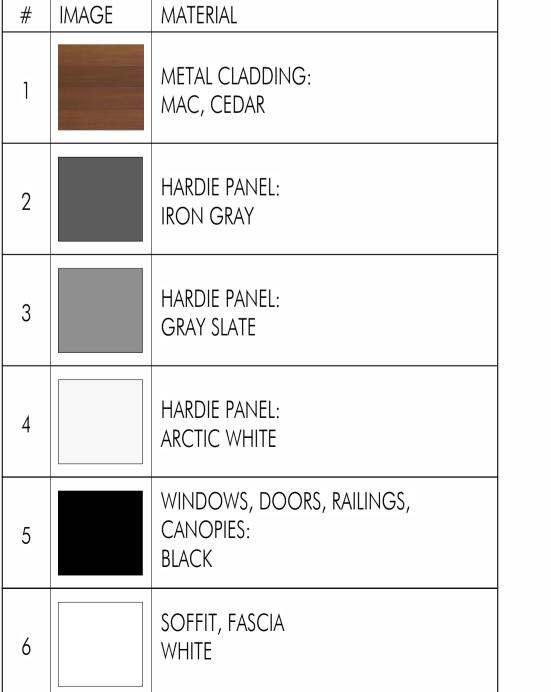

Plot Date 10.03.23 PROJECT

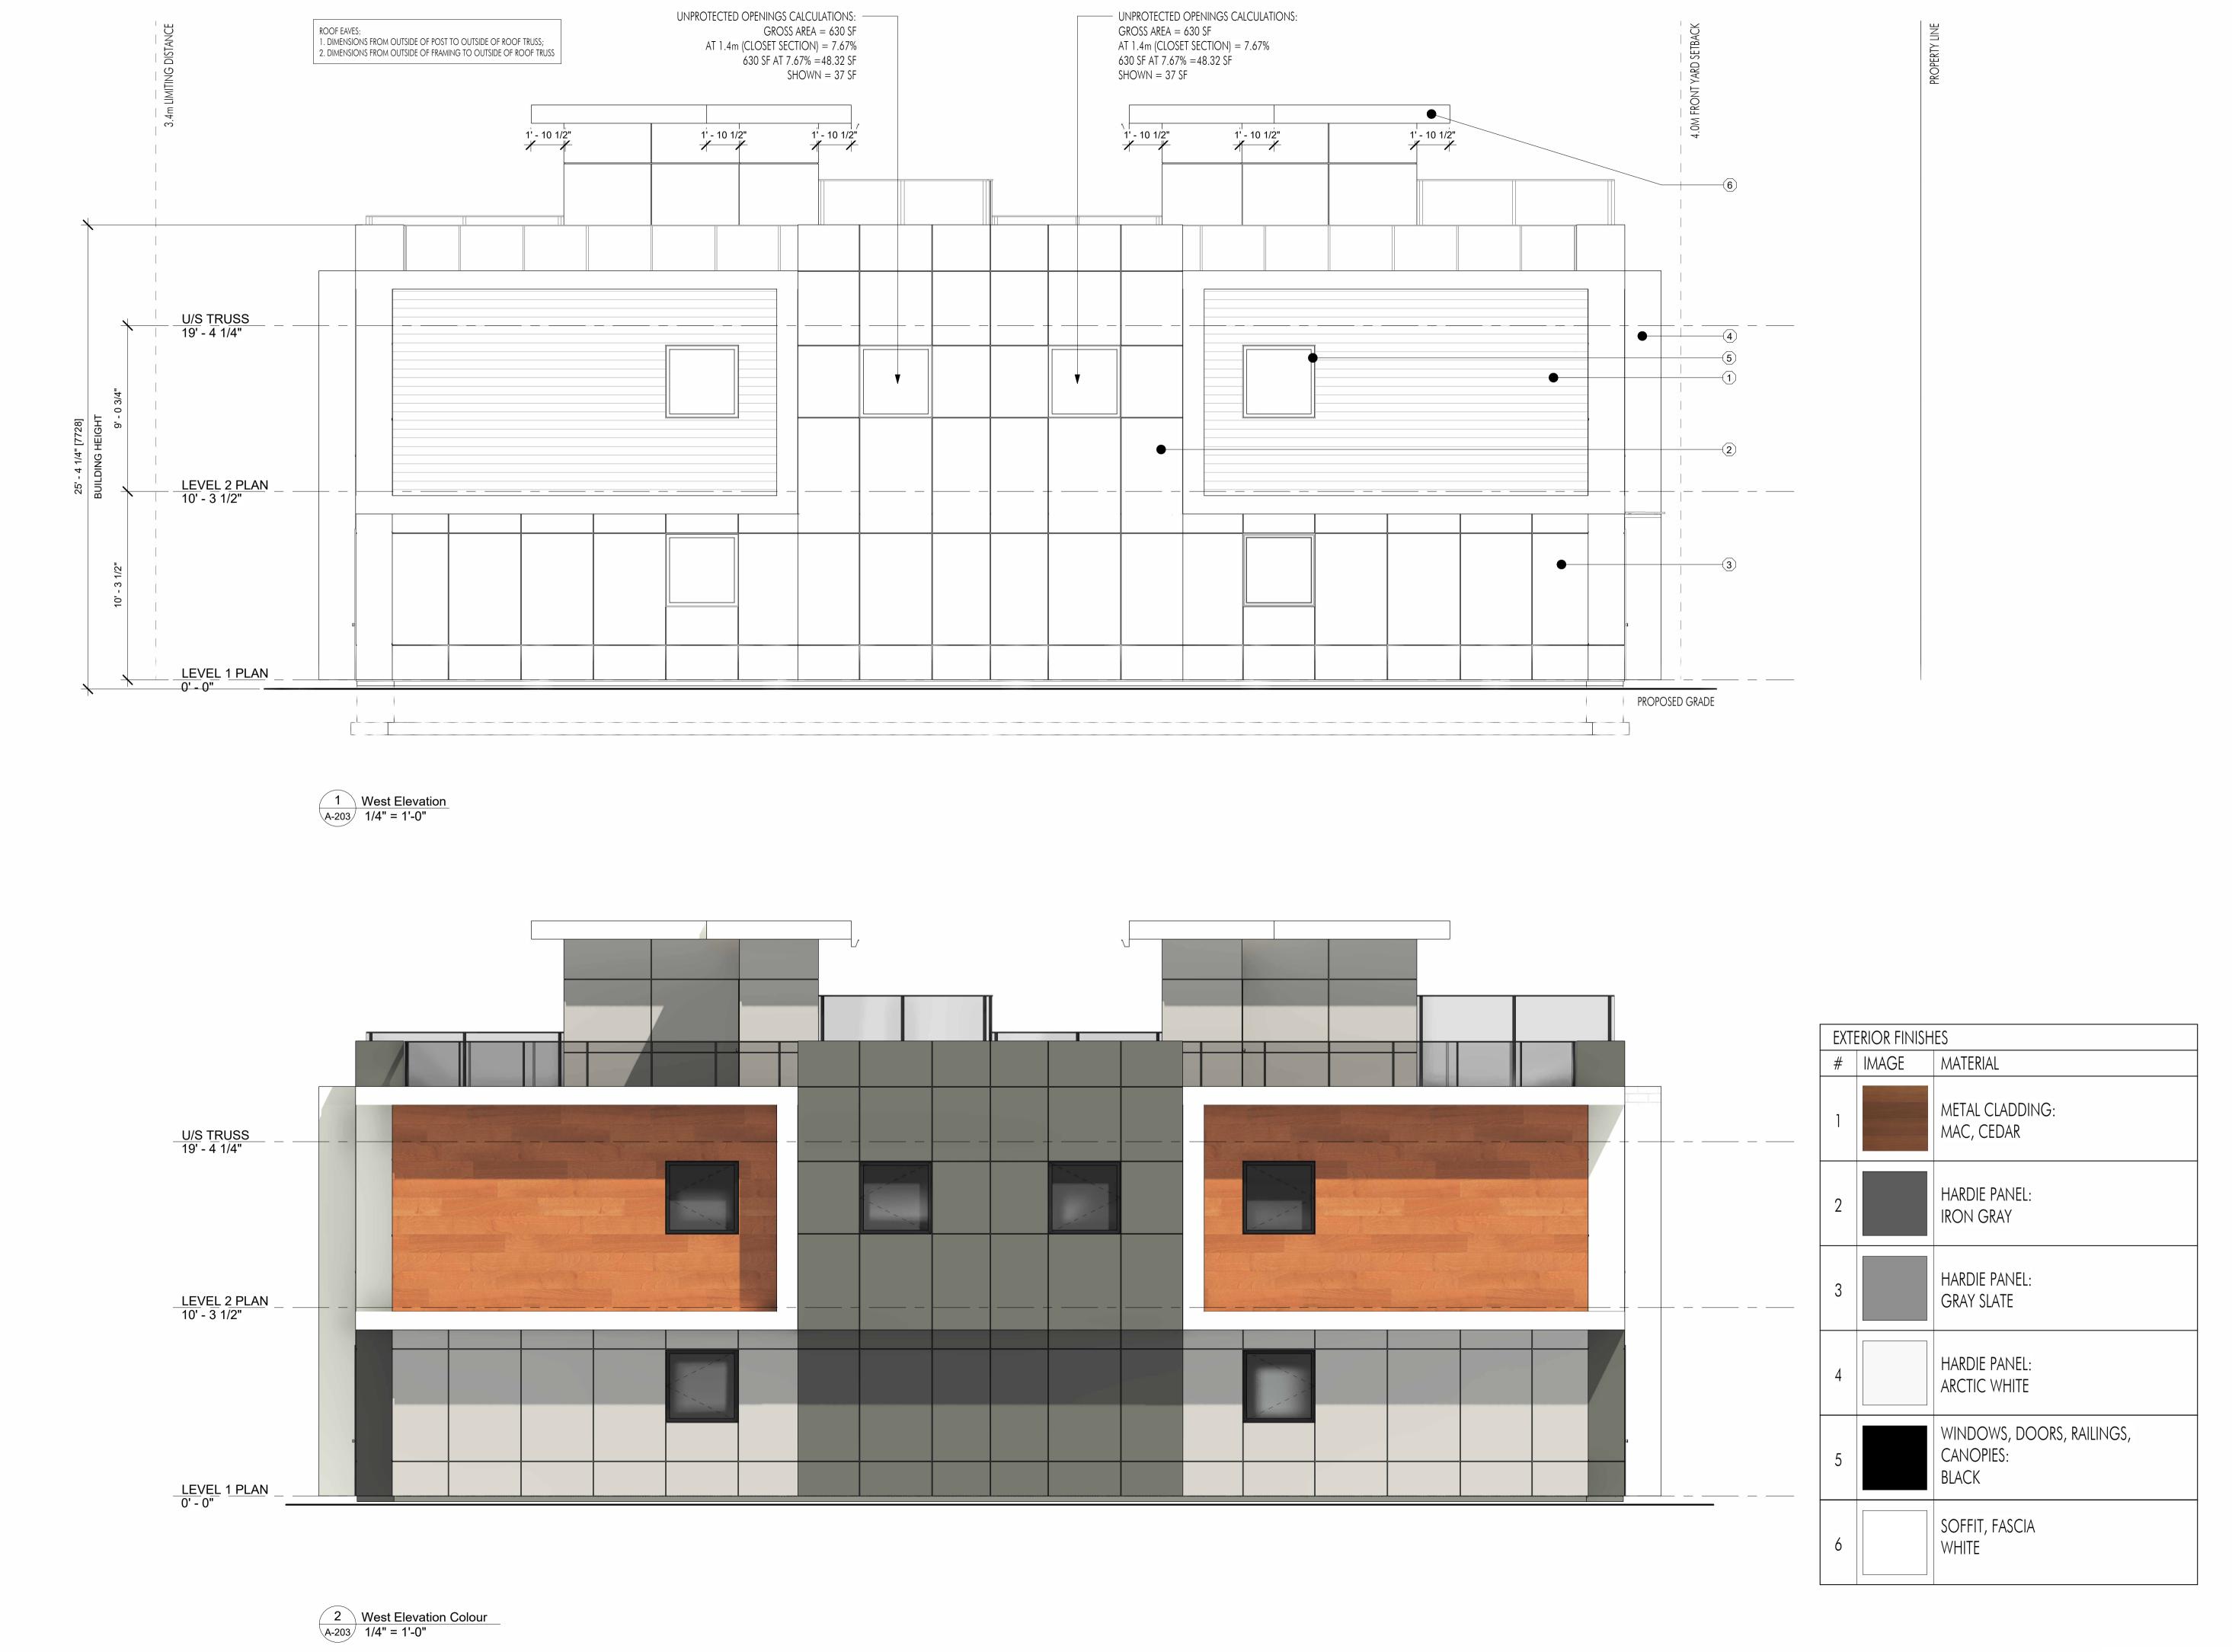

ARCHITEC

PHONE:250-448-7801

205-1626 Richter Street, Kelowna, BC V1Y 2M3 www.limearchitecture.com

COPYRIGHT.

ALL RIGHTS RESERVED

All ideas, designs, drawings and specifications are the exclusive property of LIME Architecture Inc. As instruments of service, they may not be used or reproduced in any manner without the expressed written consent of LIME Architecture Inc. All Contracting Trades shall check and verify all levels, dimensions, data and conditions on the site prior to commencement of any work. Any discrepancies are to be reported immediately to LIME Architecture Inc. Do not Scale any dimensions from this drawing.

All trades are to execute the work in accordance with the current municipality building by-laws and requirements of other local authorities having jurisdiction as well as the british columbia building code - (most recent edition) including all published revisions and addenda. All trades shall assume full responsibility for the locations and protection of all under and above ground utilities, wires and conduit connections, including (but not limited to) water, sewer, gas, hydro and telephone.

Revision No., Date and Description

07.27.23 FOR COORDINATION 10.03.23 FOR DP

0.00.20 FOR BI


Plot Date 10.03.23 PROJECT

1016 MARTIN AVE

DRAWING TITLE

ELEVATIONS

Drawing No.

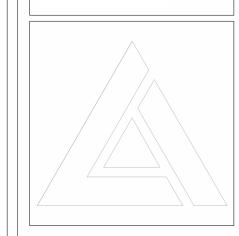





PHONE:250-448-7801

205-1626 Richter Street, Kelowna, BC V1Y 2M3 www.limearchitecture.com

COPYRIGHT.
ALL RIGHTS RESERVED

ALL RIGHTS RESERVED

All ideas, designs, drawings and specifications are the exclusive property of LIME Architecture Inc. As instruments of service, they may not be used or reproduced in any manner without the expressed written consent of LIME Architecture Inc. All Contracting Trades shall check and verify all levels, dimensions, data and conditions on the site prior to commencement of any work. Any discrepancies are to be reported immediately to LIME Architecture Inc. Do not Scale any dimensions from this drawing.

All trades are to execute the work in accordance with the current municipality building by-laws and requirements of other local authorities having jurisdiction as well as the british columbia building code - (most recent edition) including all published revisions and addenda. All trades shall assume full responsibility for the locations and protection of all under and above ground utilities, wires and conduit connections, including (but not limited to) water, sewer, gas, hydro and telephone.

Revision No., Date and Description

07.27.23 FOR COORDINATION 10.03.23 FOR DP

**Plot Date** 10.03.23


PROJECT

1016 MARTIN AVE


DRAWING TITLE

SECTIONS

Drawing No.

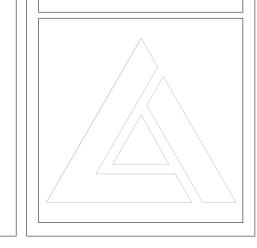

~

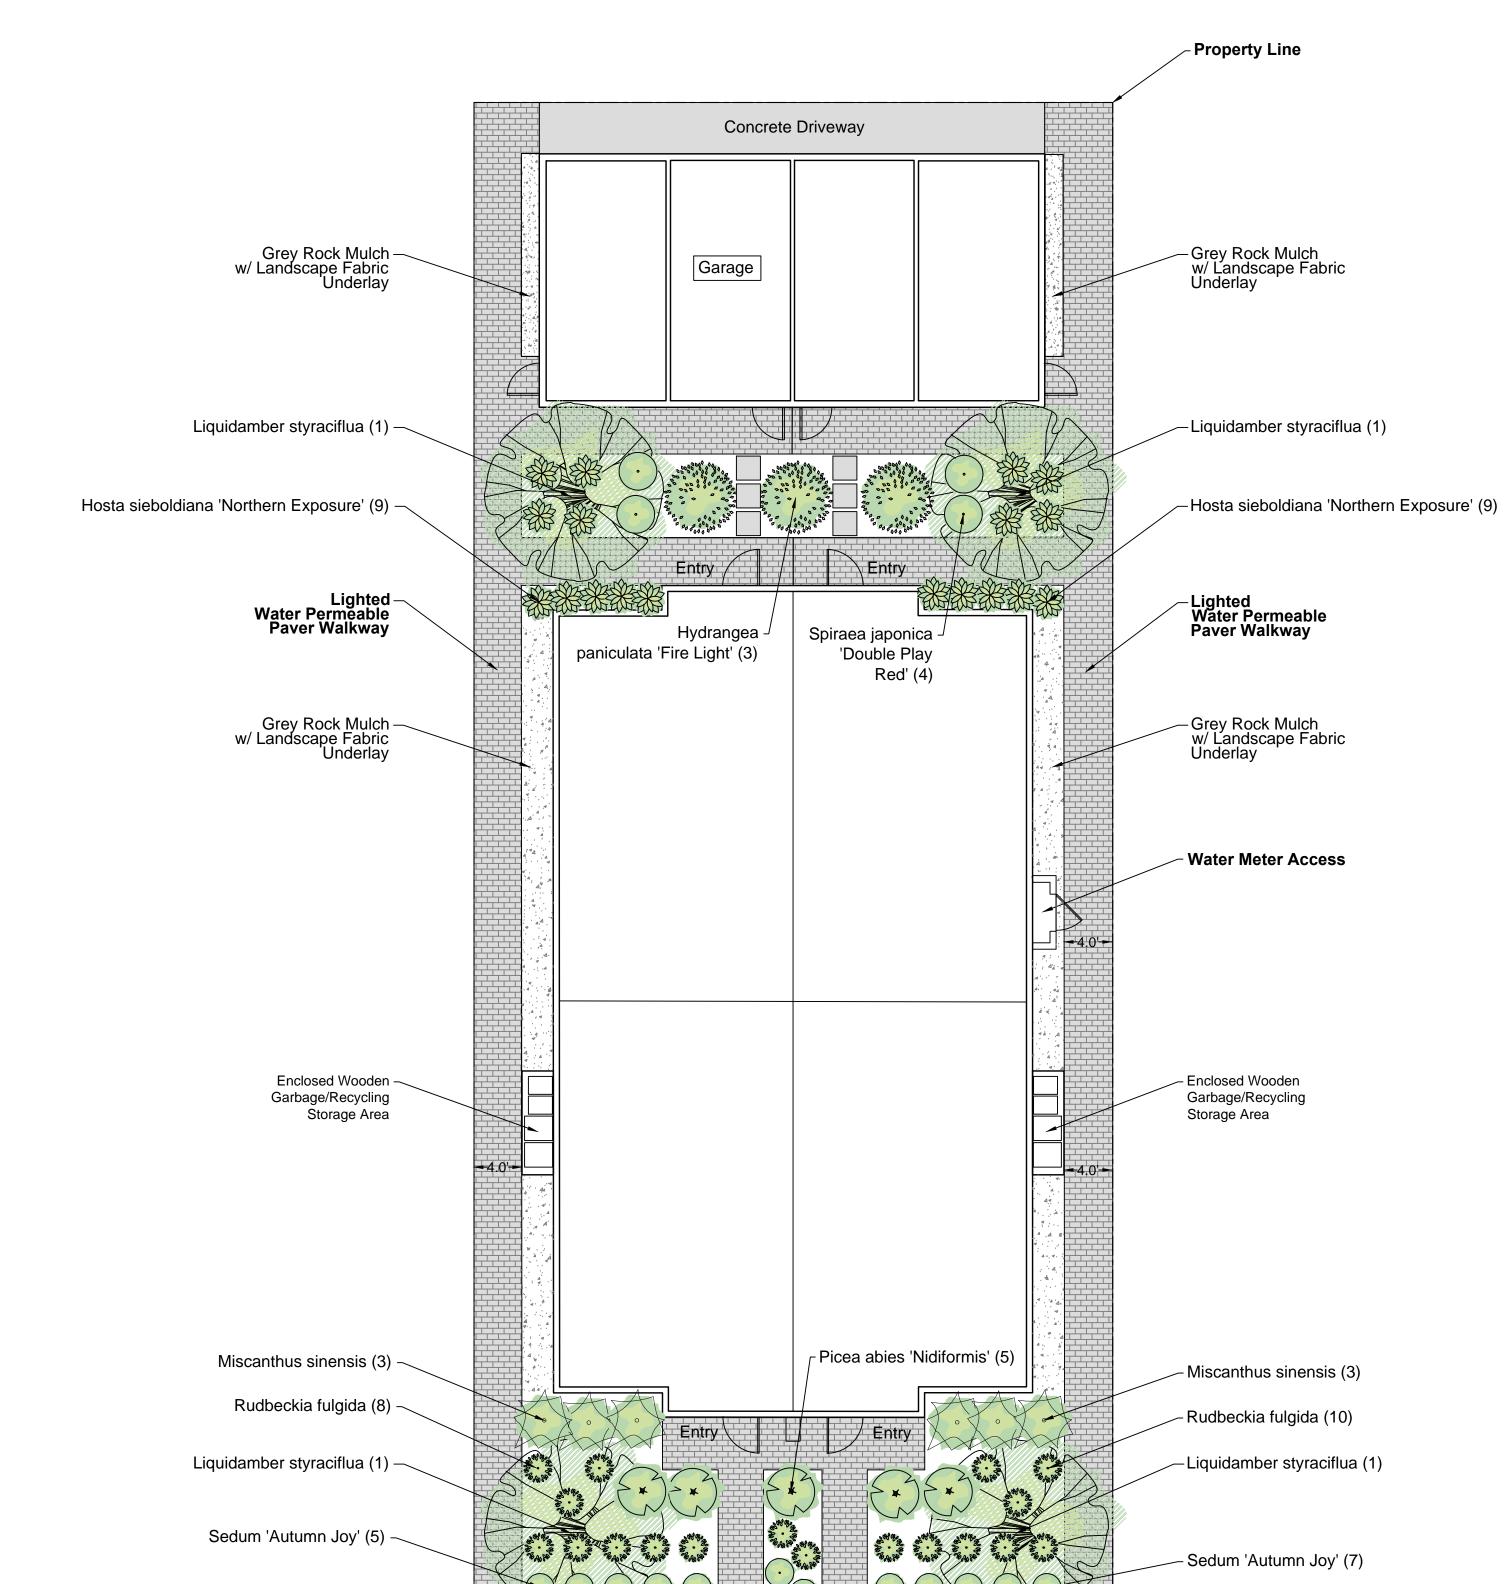

### **1016 Martin Avenue**

Landscape Edger

Landscape Plan

**Property Line** 

Landscape Edger

#### Plant List

Qty	Botanical	Common	Size
4	Liquidamber styraciflua	American Sweetgum	50mm Cal. Min.
3	Hydrangea paniculata 'Firelight'	Firelight Hydrangea	#5
5	Picea abies 'Nidiformis'	Nest Spruce	#2
4	Spiraea japonica 'Double Play Red'	'Double Play Red' Spiraea	#2
6	Miscanthus sinensis	Maiden Grass	#2
18	Hosta sieboldiana 'Northern Exposure'	'Northern Exposure' Hosta	#1
18	Rudbeckia fulgida	Goldsturm Rudbeckia	#1
12	Sedum 'Autumn Joy'	Autumn Joy Sedum	#1

- 1. Planting beds to be dressed with Black Bark Mulch.
- 2. Site to be watered with a fully automated underground irrigation system.
- 3. All structures to have positive drainage.
- 4. All matrials and landscape methods to conform to the Canadian Landscape Standard.
- 5. All plant material to be locally sourced.

Landscape Standards (7.2)	Zone	Proposed	
Min. Tree Amount	4	4	
Min. Deciduous Tree Caliper	Large - 5cm	Large - 5cm	
Min.Ratio Between Tree Sizes	Max 25%	-	
Min. Growing Medium Area	75%	75%	
Min. Growing Media volumes per tree	15m3	15m3	
Retention of existing trees on site?	no		
Landscape graded areas	No significant slope		
Fence Height	N/A		
Riparian management area?	No		
Surface parking lot?	No		
Refuse and recycle bins screened?	Yes		



